

Kenton C. Ward, CFM  
Surveyor of Hamilton County  
Phone (317) 776-8495  
Fax (317) 776-9628

Suite 188  
One Hamilton County Square  
Noblesville, Indiana 46060-2230

June 6, 2006

To: Hamilton County Drainage Board

Re: Towne Lake Drain, Windsor Grove II Arm

Attached is a petition filed by Steve A. Wilson, Inc. along with a non-enforcement request, plans, calculations, quantity summary and assessment roll for the Windsor Grove II Arm, Towne Lake Drain to be located in Clay Township. I have reviewed the submittals and petition and have found each to be in proper form.

I have made a personal inspection of the land described in the petition. Upon doing so, I believe that the drain is practicable, will improve the public health, benefit a public highway, and be of public utility and that the costs, damages and expenses of the proposed drain will probably be less than the benefits accruing to the owners of land likely to be benefited. The drain will consist of the following:

6" SSD	5,083 ft.	18" RCP	962 ft.	27" RCP	289 ft.
12" RCP	993 ft.	21" RCP	24 ft.	30" RCP	43 ft.
15" RCP	520 ft.	24" RCP	365 ft.	Open Ditch	468 ft.

The total length of the drain will be 8,747 feet.

The retention ponds (Lakes #1, 2, and existing pond) located in Common Area #2 and #5 are to be considered part of the regulated drain. Pond maintenance shall include the inlet, outlet, sediment removal and erosion control along the banks as part of the regulated drain. The maintenance of the ponds (lakes), such as mowing and aquatic vegetation control, will be the responsibility of the Homeowners Association. The Board will also retain jurisdiction for ensuring the storage volume for which the ponds (lakes) were designed will be retained, thereby, allowing no fill or easement encroachments.

The subsurface drains (SSD) to be part of the regulated drain are those located under the curbs and those main lines between lots or in rear yards. Only the main SSD lines, which are located within the easement (right of way), are to be maintained as regulated drain. Laterals for individual lots will not be considered part of the regulated drain.

I have reviewed the plans and believe the drain will benefit each lot equally. Therefore, I recommend each lot be assessed equally. I also believe that no damages will result to landowners by the construction of this drain. I recommend a maintenance assessment of \$2.00 per acre for common areas and platted lots, \$2.00 per acre for roadways, with a \$30.00 minimum. With this assessment the total annual assessment for this drain/this section will be \$1,106.10.

The petitioner has submitted surety for the proposed drain at this time. The sureties which are in the form of a Letter of Credit are as follows:


Agent: Irwin Union Bank  
Date: March 20, 2006  
Number: 18-06  
For: Storm Sewers, SSD and Erosion Control  
Amount: \$246,360.00

Parcels assessed for this drain will also be assessed for the Fitch & Jessup Drain.

I believe this proposed drain meets the requirements for Urban Drain Classification as set out in IC 36-9-27-67 to 69. Therefore, this drain shall be designated as an Urban Drain.

I recommend that upon approval of the above proposed drain that the Board also approve the attached non-enforcement request. The request is for the reduction of the regulated drain easement to those easement widths as shown on the secondary plat for Windsor Grove II as recorded in the office of the Hamilton County Recorder.

I recommend the Board set a hearing for this proposed drain for November 27, 2006.

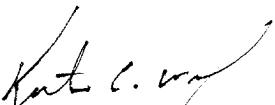

Kenton C. Ward, CFM  
Hamilton County Surveyor

KCW/pll

STATE OF INDIANA              )  
                                )  
COUNTY OF HAMILTON      )

TO: HAMILTON COUNTY DRAINAGE BOARD  
% Hamilton County Surveyor  
One Hamilton County Square, Suite 188  
Noblesville, IN. 46060-2230

In the matter of              Windsor Grove II              Subdivision, Section  
                                    Drain Petition.

Petitioner is the owner of all lots in the land affected by the proposed new regulated drain. The drainage will affect various lots in Windsor Grove II, a subdivision in Hamilton County, Indiana. The general route of such drainage shall be in existing easements and along public roads as shown in the plans on file in the Surveyor's Office.

Petitioner believes that the cost, damages and expenses of the proposed improvement will be less than the benefits which will result to the owners of the land likely to be benefited thereby. Petitioner believes the proposed improvements will:

- (a) improve public health
- (b) benefit a public street
- (c) be of public utility


Petitioner agrees to pay the cost of construction of the drainage system and requests periodic maintenance assessments by the Board thereafter.

The Petitioner also agrees to the following:

1. To provide the Drainage Board a Performance Bond or Non-Revocable Letter of Credit for the portion of the drainage system which will be made a regulated drain. The bond will be in the amount of 120% of the Engineer's estimate. The bond will be in effect until construction of 100% of the system is completed and so certified by the Engineer.
2. The Petitioner shall retain an Engineer throughout the construction phase. At completion of the project the Petitioner's Engineer shall certify that the drainage system which is to be maintained as a regulated drain has been constructed as per construction plans.
3. The Petitioner agrees to request in writing to the County Surveyor any changes from the approved plan and must receive written authorization from the County Surveyor prior to implementation of the change. All changes shall be documented and given to the Surveyor to be placed in the Drain file.
4. The Petitioner shall instruct his Engineer to provide a reproducible print on a 24" x 36" Mylar of the final design of the Drainage System. This shall be submitted to the County Surveyor prior to the release of the Performance Bond.
5. The Petitioner shall comply with the Erosion Control Plan as specified on the construction plans. Failure to comply with the Erosion Control Plan shall be determined by the Board as being an obstruction to the drainage system. The County Surveyor shall immediately install or repair the needed measures at Petitioner's cost as per IC 36-9-27-46.

The Petitioner further requests that the Drain be classified as an Urban Drain as per IC 36-9-27-69(d).

**RECORDED OWNER(S) OF LAND INVOLVED**

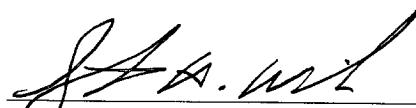

Signed

Steven A. Wilson

Printed Name

January 3, 2005

Date

Signed

Printed Name

Date

Signed

Printed Name

Date

Signed

Printed Name


Date

FINDINGS AND ORDER  
CONCERNING THE MAINTENANCE OF THE  
**Towne Lake Drain, Windsor Grove Section II Arm**


On this **27th day of November, 2006**, the Hamilton County Drainage Board has held a hearing on the Maintenance Report and Schedule of Assessments of the **Towne Lake Drain, Windsor Grove Section II Arm**.

Evidence has been heard. Objections were presented and considered. The Board then adopted the original/amended Schedule of Assessments. The Board now finds that the annual maintenance assessment will be less than the benefits to the landowners and issues this order declaring that this Maintenance Fund be established.


HAMILTON COUNTY DRAINAGE BOARD

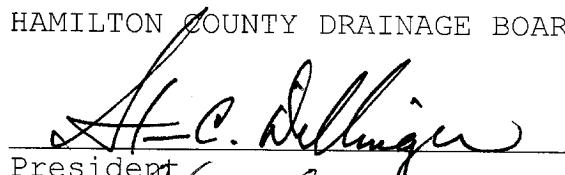  
A.C. Dillinger

President

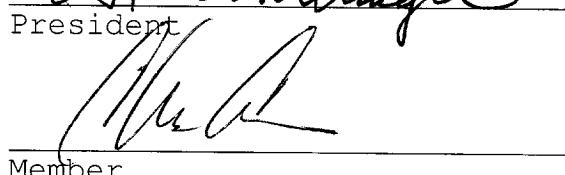  
M.A.


Member

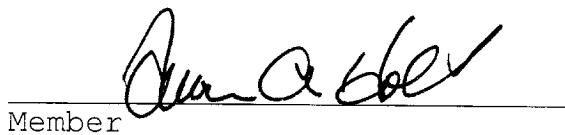  
Dan A. Abel

Member

Attest:

  
Lynette Masbaugh

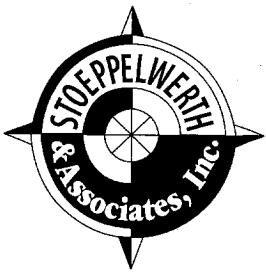

# CONSULTING ENGINEERS • LAND SURVEYORS

David J. Stoeppelwerth, P.E., P.L.S.  
President, C.E.O.

Curtis C. Huff, P.L.S.  
Vice-President, C.O.O.

R.M. Stoeppelwerth, P.E., P.L.S.  
President Emeritus

## CERTIFICATE OF COMPLETION AND COMPLIANCE

To: Hamilton County Surveyor

Re: **Windsor Grove II**

I hereby certify that:

1. I am a Registered Land Surveyor or Engineer in the State of Indiana.
2. I am familiar with the plans and specifications for the above referenced subdivision.
3. I have personally observed and supervised the completion of the drainage facilities for the above referenced subdivision.
4. The drainage facilities within the above referenced subdivision to the best of my knowledge, information and belief have been installed and completed in conformity with all plans and specifications.

Signature: Jeffory W. Darling Date: October 12, 2006

Type or Print Name: Jeffory W. Darling

Business Address: Stoeppelwerth & Associates, Inc.

9940 Allisonville Road, Fishers, Indiana 46038

Telephone Number: (317) 849-5935

SEAL

INDIANA REGISTRATION NUMBER

900017



9940 Allisonville Road • Fishers, Indiana 46038-2005 • (317) 849-5935 • 1-800-728-6917 • FAX: (317) 849-5942

This copy is from the Digital Archive of the Hamilton County Surveyor's Office; Noblesville, In 46060



Kenton C. Ward, CFM  
Surveyor of Hamilton County  
Phone (317) 776-8495  
Fax (317) 776-9628

Suite 188  
One Hamilton County Square  
Noblesville, Indiana 46060-2230

To: Hamilton County Drainage Board

February 8, 2007

Re: Towne Lakes: Windsor Grove Section 2

Attached are as-builts, certificate of completion & compliance, and other information for Windsor Grove Section 2. An inspection of the drainage facilities for this section has been made and the facilities were found to be complete and acceptable.

During construction, changes were made to the drain, which will alter the plans submitted with my report for this drain-dated June 6, 2006. The report was approved by the Board at the hearing held November 27, 2006. (See Drainage Board Minutes Book 9, Pages 584-586) The changes are as follows:

Structure:	Length:	Size	Material:	Up Invert:	Dn Invert	Grade:	Changes(ft):
615-614	154	12	RCP	890.58	887.6	1.94	12
614-613	30	15	RCP	887.6	887.43	0.57	
613-612	59	18	RCP	887.43	887.22	0.36	7
612-611	157	18	RCP	887.22	886.68	0.34	-2
611-610	76	18	RCP	886.68	884.99	2.22	6
609-608	111	12	RCP	887.39	887.03	0.32	-4
608-607	60	15	RCP	887.03	886.86	0.28	
607-606	81	15	RCP	886.82	884.92	2.4	3
601-600A	184	12	RCP	884.92	883.52	0.76	-10
600A-600	98	12	RCP	883.52	882.66	0.88	7
600B-600A	72	12	RCP	885	883.52	2.06	19
605-604	83	12	RCP	885.41	885	0.49	-4
603-602	41	30	RCP	883.01	882.97	0.09	-2
627-626	30	15	RCP	883.29	883.12	0.57	
626-625	136	18	RCP	883.12	882.56	0.41	
625-624	154	18	RCP	882.56	882.06	0.31	2
628-621	198	12	RCP	878.51	878.03	0.24	-4
631-630	30	12	RCP	882.71	882.42	0.97	
630-629	63	18	RCP	882.42	882.13	0.46	-1
629-624	22	21	RCP	882.13	882.08	0.23	-2
624-623	185	24	RCP	882.08	881.46	0.34	
623-622	30	24	RCP	881.46	881.35	0.37	

622-621	149	24	RCP	881.35	878.03	2.23	-1
621-620	20	27	RCP	878.03	877.97	0.3	-1
620-619	30	27	RCP	877.97	877.81	0.53	
619-618	237	27	RCP	873.79	873.03	0.32	-1
635A-635	123	15	RCP	882.9	882.34	0.46	-2
635-634	193	15	RCP	882.34	881.7	0.33	-4
634-633	103	18	RCP	881.7	881.23	0.45	
633-632	228	18	RCP	875.73	873	1.2	
617-616	80	12	RCP	872.99	872.71	0.35	1

**6" SSD Streets:**

Iron Horse Ln	1464
Roxley Bend	515.5
Noma Ct	483.5
x2	
<b>Total:</b>	<u>4926</u>

<b>Other Drain:</b>	
Open	515
<b>Total:</b>	<u>515</u>

**RCP Pipe Totals:**

12	1010
15	517
18	976
21	22
24	364
27	287
30	41
<b>Total:</b>	<u>3217</u>

The length of the drain due to the changes described above is now **8,658 feet.**

The non-enforcement was approved by the Board at its meeting on November 27, 2006 and recorded under instrument #200600071264.

The following sureties were guaranteed by Irwin Union Bank and released by the Board on its January 8, 2007 meeting.

**Bond-LC No:** 18-06


**Insured For:** Storm Sewers, Erosion Control

**Amount:** \$246,360.00

**Issue Date:** March 20, 2006

I recommend the Board approve the drain's construction as complete and acceptable.

Sincerely,

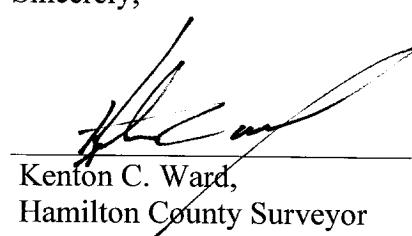


Kenton C. Ward,  
Hamilton County Surveyor

KCW/slm


# RECORD DRAWING

# WINDSOR GROVE II

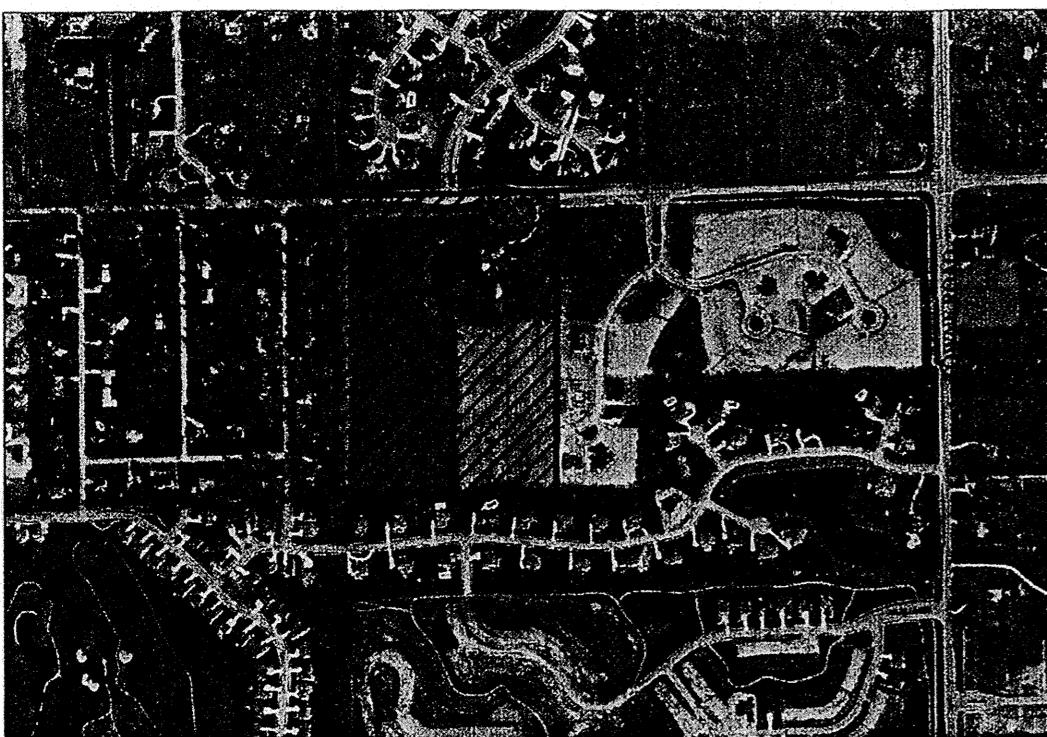

LOCATION MAP

Developed by:  
**STEVEN A. WILSON, INC.**  
**937 KEYSTONE WAY**  
**CARMEL, INDIANA 46082**  
**PHONE # (317)-846-2555**  
**FAX # (317)-846-9594**  
**CONTACT PERSON: STEVE WILSON**

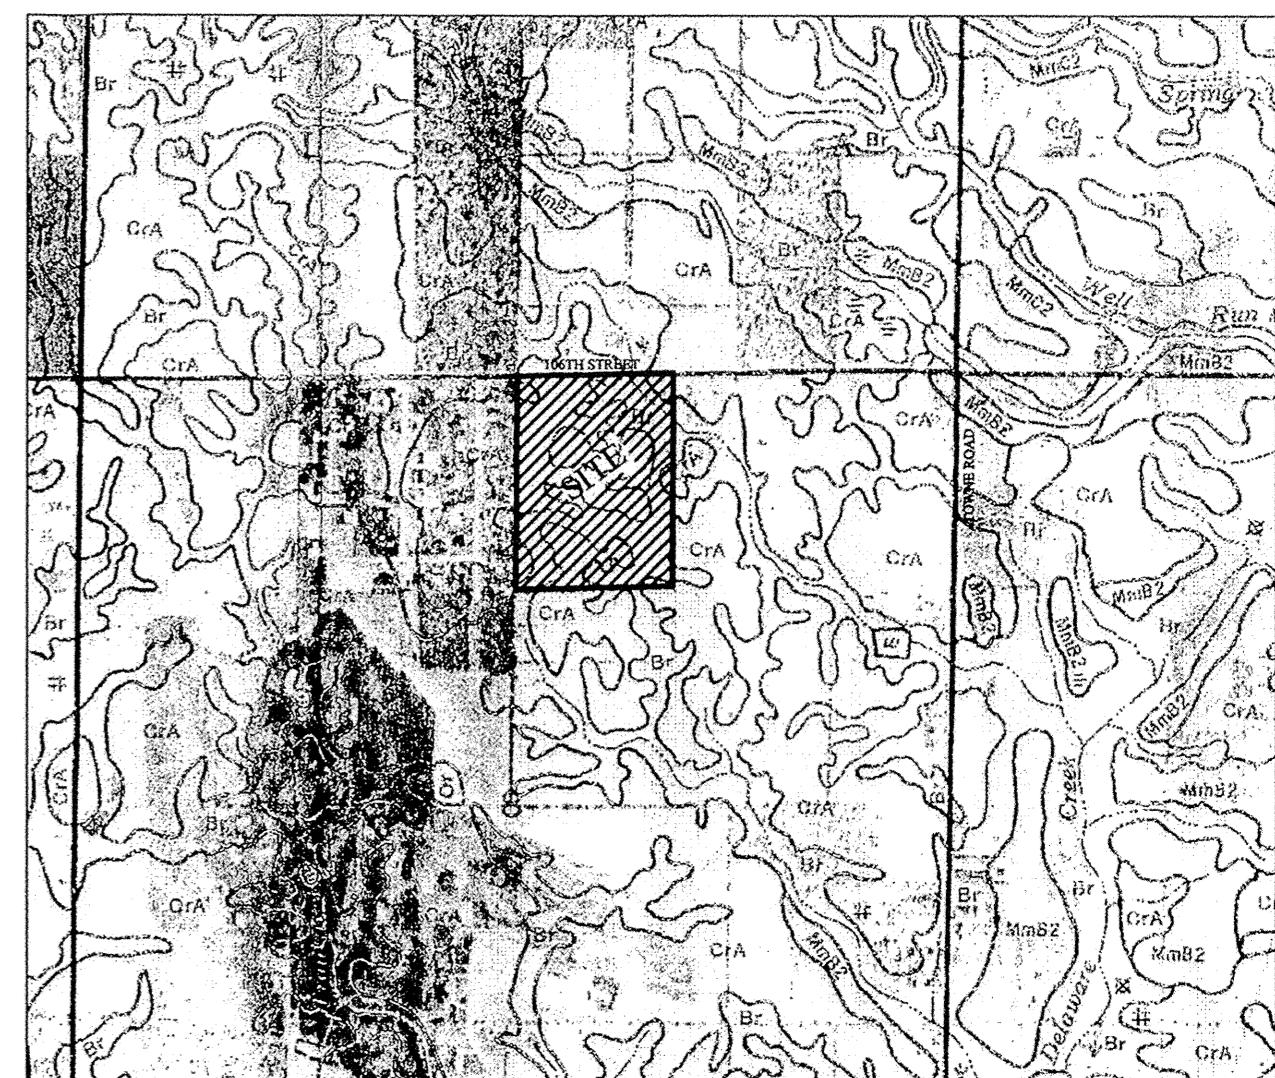


SOILS MAP

## RECORD DRAWING

*Jeffory W. Darling*  
**JEFFORY W. DARLING**  
 Registered Land Surveyor  
 No. 900017

9/26/06

DATE

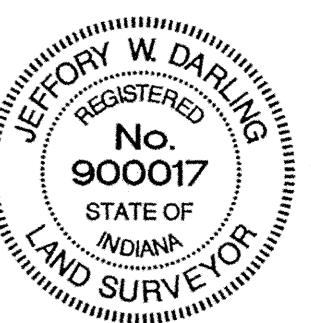


DESIGN DATA  
 30 LOTS  
 30.006 AC. = 0.99 LOTS/ACRE

IRON HORSE LANE  
 NOMA COURT  
 ROXLEY ROAD  
 1480.78 L.F.  
 469.67 L.F.  
 511.96 L.F.


SPEED LIMIT: 25 M.P.H.

### PLANS PREPARED BY:

**STOEPPELWERTH & ASSOCIATES, INC.**  
**CONSULTING ENGINEERS & LAND SURVEYORS**  
**9940 ALLISONVILLE ROAD**  
**FISHERS, INDIANA 46038**  
**PHONE: (317)-849-5935**  
**FAX: (317)-849-5942**

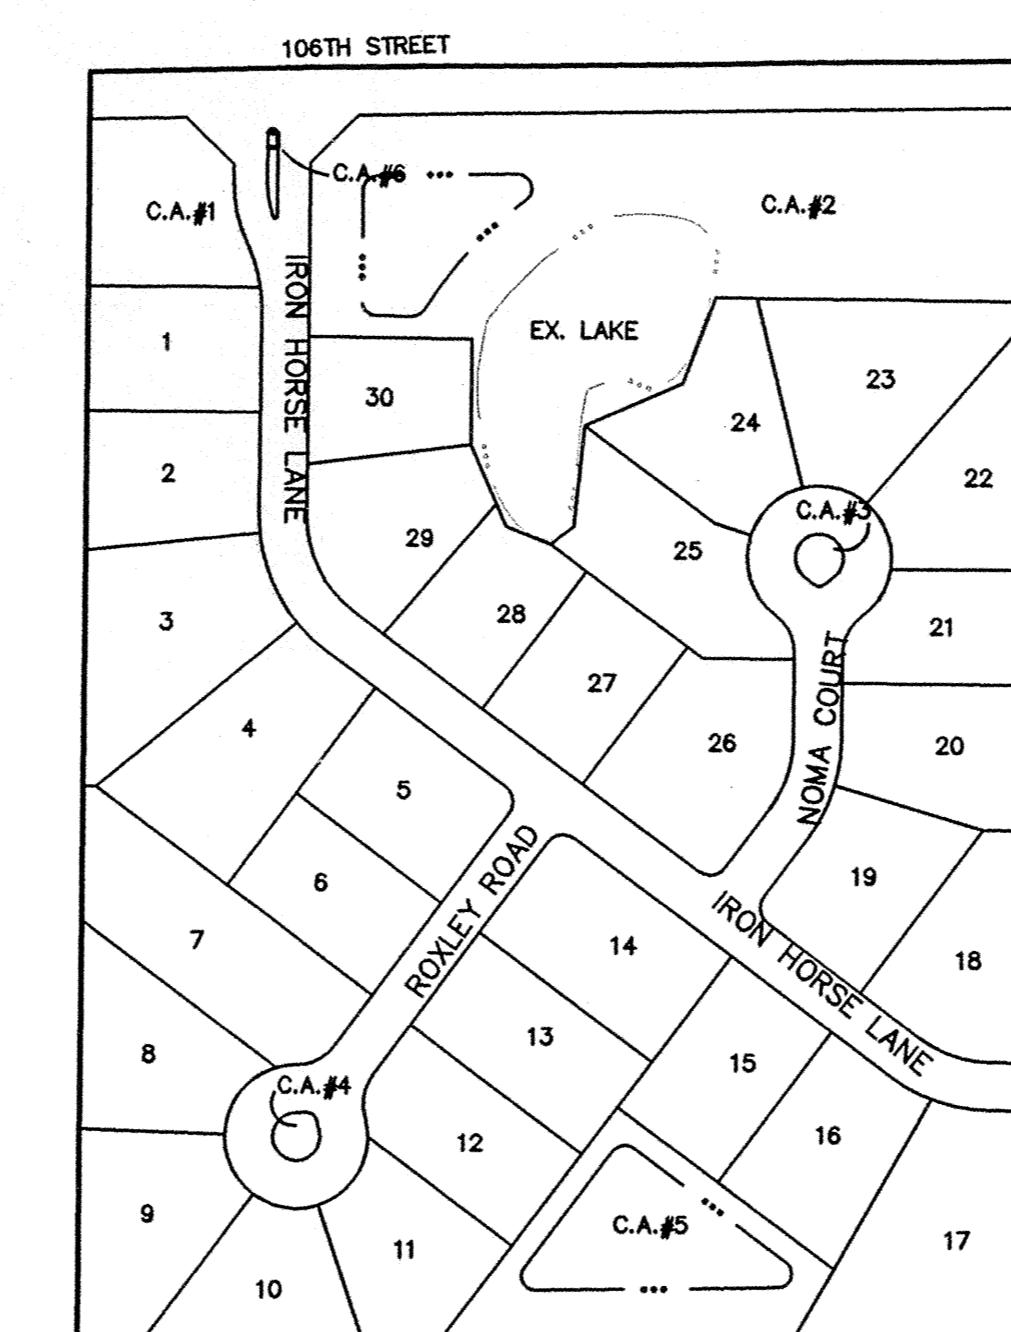

SCALE: 1" = 200'

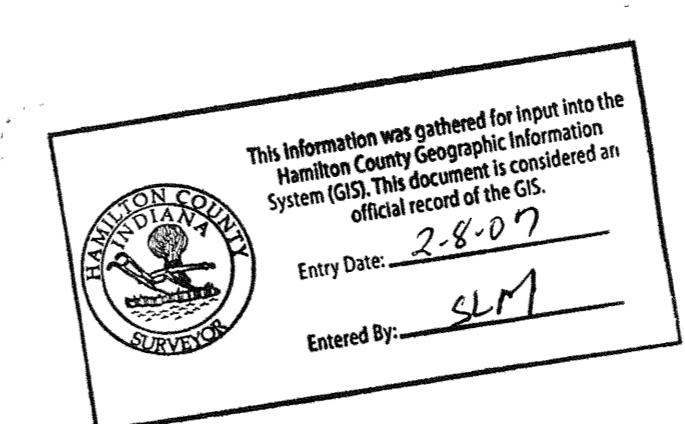

### PLANS CERTIFIED BY:

*James O. Rinehart IV*  
**JAMES O. RINEHART IV**  
 PROFESSIONAL ENGINEER  
 NO. 10200495  
 1/3/06  
 DATE



INDEX	
SHT.	DESCRIPTION
C001	COVER SHEET
C100	TOPOGRAPHICAL SURVEY
C200-C201	SITE DEVELOPMENT PLAN/PROPOSED GRADING PLAN
C300-C302	EROSION CONTROL PLAN & SPECIFICATIONS
C400-C405	STREET PLAN & PROFILES/ENTRANCE DETAIL/INTERSECTION DETAILS/TRAFFIC CONTROL PLAN/TRAFFIC MAINTENANCE PLAN/PAVEMENT POLICY
C500-C502	SANITARY SEWER PLAN & PROFILES
C600-C602	STORM SEWER PLAN & PROFILES
C800-C803	CONSTRUCTION DETAILS SANITARY STORM STREET HANDICAPPED RAMPS



REVISIONS	
SHT.	DESCRIPTION
ALL	REVISED PER TAC COMMENTS 1/31/06
C200 & C201	REVISED PER HAMILTON CO SURVEYORS OFFICE 2/21/06
ALL	REVISED PER AGENCY COMMENTS 2/28/06
ALL	REVISED PER DIRT ANALYSIS 3/1/06
ALL	REVISED PER AGENCY COMMENTS 3/2/06
ALL	REVISED PER DEVELOPER 4/14/06
C406	REVISED PER HAMILTON COUNTY HIGHWAY DEP. 4/21/06






## RECORD DRAWING

*Jeffory W. Darling*  
JEFFORY W. DARLING  
Registered Land Surveyor  
No. 900017

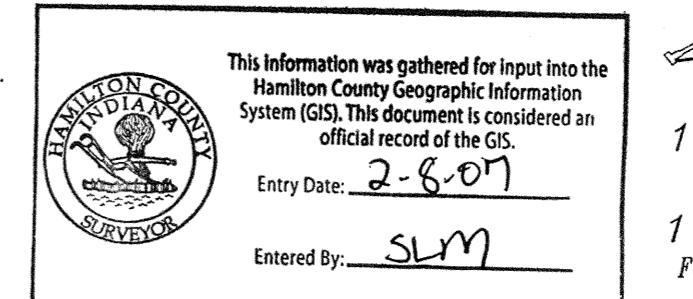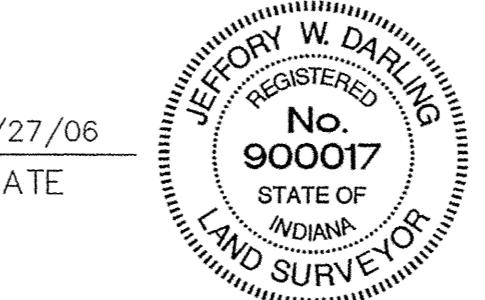

"HOLEY MOLEY"  
SAYS:  
CAUTION  
LOCATION OF ALL EXISTING UNDERGROUND UTILITIES SHOWN ON THIS PLAN ARE BASED UPON ABOVE GROUND EVIDENCE (INCORPORATED BUT NOT LIMITED TO, MONOLITHS, INLETS, VALVES, & MARKS MADE UPON THE GROUND BY OTHERS) AND ARE SPECULATIVE IN NATURE. THERE MAY ALSO BE OTHER UNKNOWN EXISTING UTILITIES WHICH THERE IS NO ABOVE GROUND EVIDENCE FOR OR WHICH NO ABOVE GROUND EVIDENCE WAS OBSERVED. THE EXACT LOCATIONS OF SAID EXISTING UNDERGROUND UTILITIES SHOULD BE VERIFIED BY THE CONTRACTOR PRIOR TO ANY AND ALL CONSTRUCTION.

1-800-382-5544  
CALL TOLL FREE  
1-800-428-5200  
FOR CALLS OUTSIDE OF INDIANA

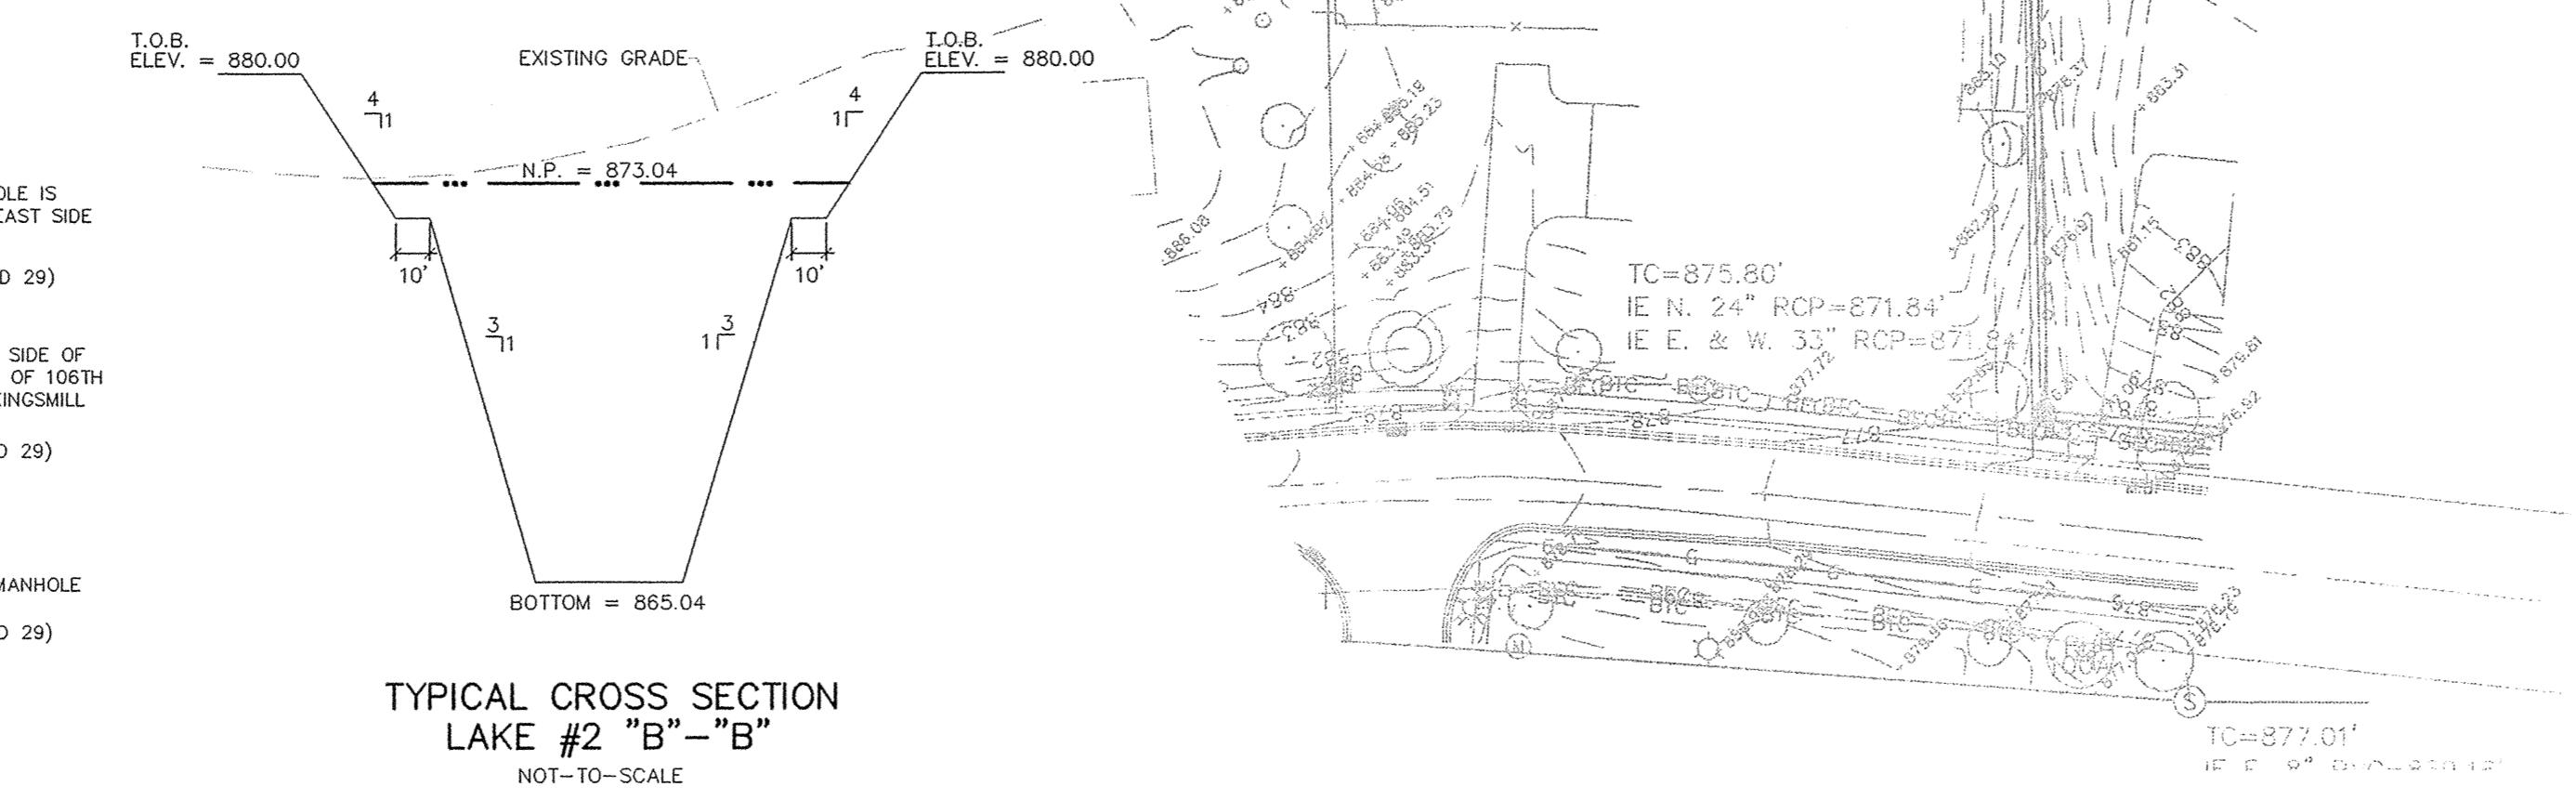

BM & TBM HISTORY:  
JRL RAN THE BENCH FROM TBM 1 THROUGH TBM 2 TO TBM 3.  
FIELD BOOK 416, PAGE 76-79

REFERENCE BENCHMARK:

TBM 1 - A RAILROAD SPIKE IN THE WEST SIDE OF A POWER POLE. SAID POLE IS LOCATED ON THE SOUTH LINE OF CAMDEN WALK SUBDIVISION AND ON THE EAST SIDE OF TOWNE ROAD. (ITEM FROM S & A JOB NUMBER 33697)

ELEVATION: 870.46" (NGVD 29)

TBM 2 - A RAILROAD SPIKE, ONE FOOT ABOVE THE GROUND, IN THE SOUTH SIDE OF POWER POLE NUMBER 39130A. SAID POLE IS LOCATED ON THE NORTH SIDE OF 106TH STREET AND 70 FEET WEST OF THE CENTER ISLAND AT THE ENTRANCE TO KINGSMILL SUBDIVISION.

ELEVATION: 891.02" (NGVD 29)


ITEM 3 - WINDSOR GROVE (S & A JOB NUMBER 33697) ASBUILT SANITARY MANHOLE NUMBER 712.

ELEVATION: 880.90" (NGVD 29)

BENCH NOTES TYPED BY: RJC 9/19/2005  
CHECKED BY:



CERTIFIED: 1/3/06

STOPPELWERTH & ASSOCIATES, INC.  
CONSULTING ENGINEERS & LAND SURVEYORS  
9940 Allisonville Rd., Fishers, IN 46038-2005  
Phone: (317) 849-5935 Fax: (317) 849-5942  
Toll Free: (800) 728-6917

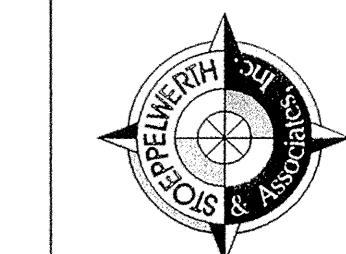

SITE DEVELOPMENT PLAN  
WINDSOR GROVE II

DRAWN BY: TWF  
CHECKED BY: BKR  
SHEET NO. C201  
S. & A. JOB NO. 52645

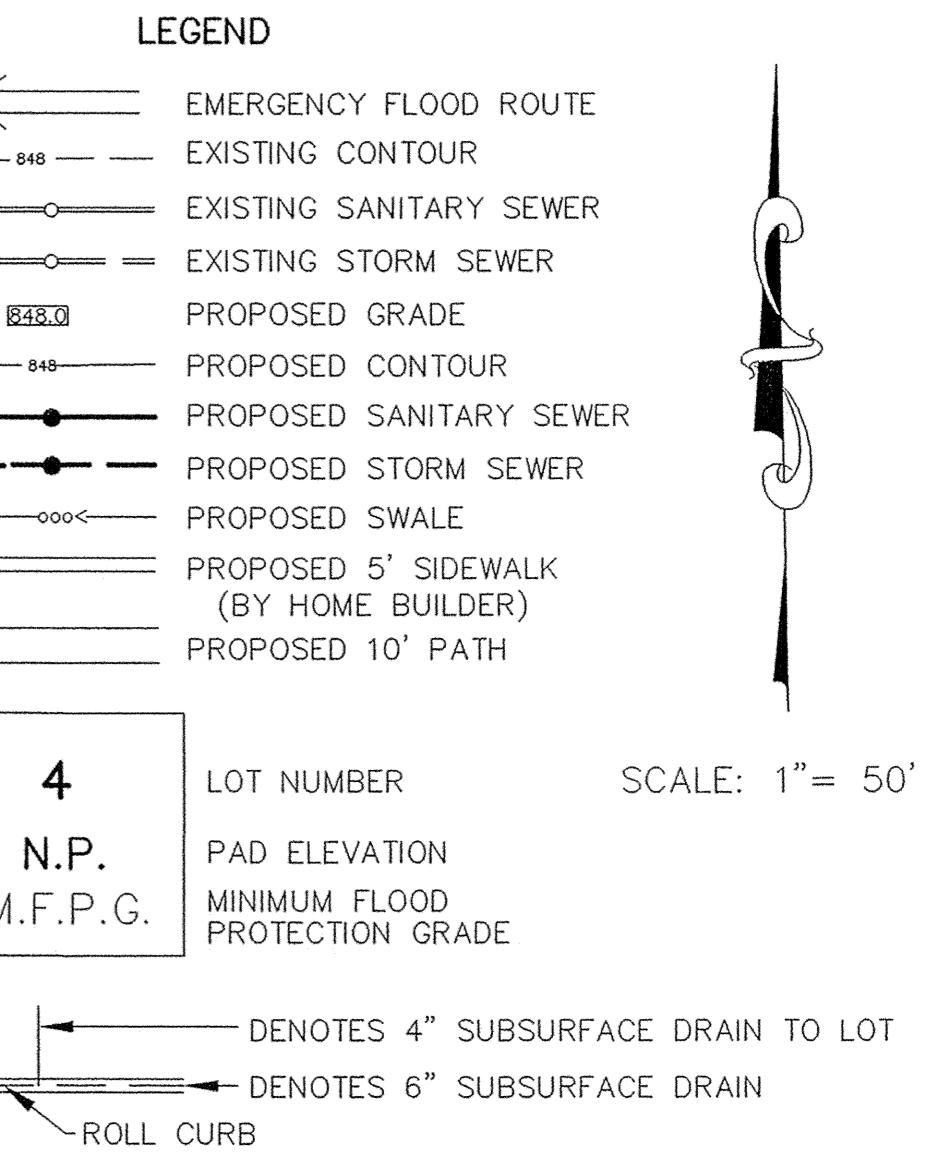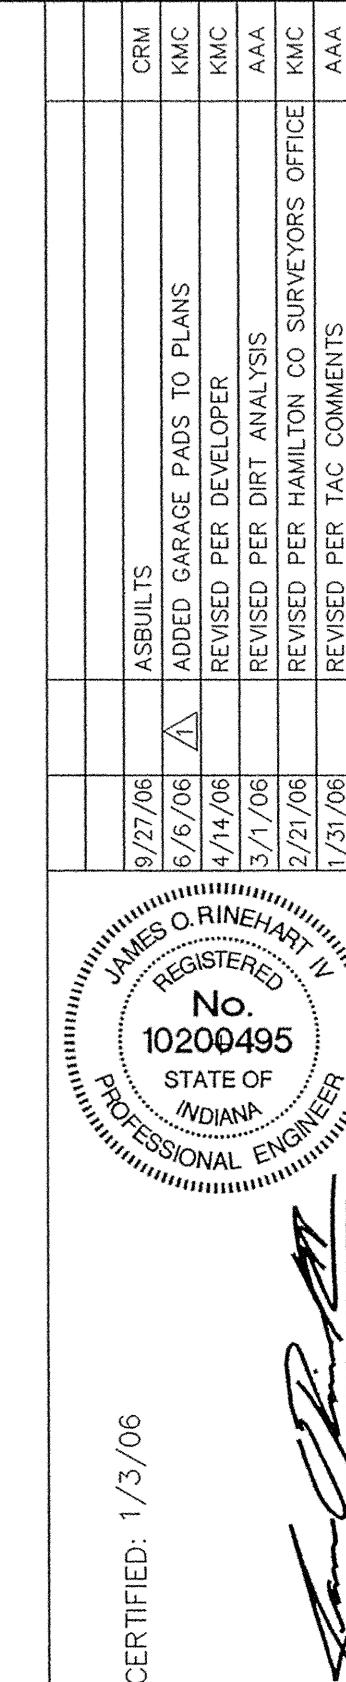

4  
N.P.  
M.F.P.G.  
LOT NUMBER  
PAD ELEVATION  
MINIMUM FLOOD PROTECTION GRADE  
DENOTES 4" SUBSURFACE DRAIN TO LOT  
DENOTES 6" SUBSURFACE DRAIN  
ROLL CURB

NOTE: DECORATIVE SIGNS, SPRINKLER SYSTEMS, TREES, LANDSCAPING MOUNDS, LIGHT POLES, OR OTHER SUCH AMENITIES ARE NOT PERMITTED IN THE RIGHT-OF-WAY.  
NOTE: A DEBRIS GUARD SHALL BE INSTALLED ON ALL UPSTREAM OPEN-ENDED INLETS AND AT THE POND OUTFALL PIPE.  
NOTE: NO PROPOSED DRIVEWAY SHALL ENTRANCE ON ANY SIDEYARD EASEMENT.  
NOTE: THERE ARE TO BE NO WATER VALVES OR MANHOLES WITHIN THE PAVEMENT, CURBS, OR SIDEWALKS.  
NOTE: ALL EXISTING PAVEMENT SHALL BE SAW CUT TO A CLEAN EDGE WHERE NEW PAVEMENT (FOR WIDENING) IS TO BE INSTALLED ADJACENT TO EXISTING PAVEMENT.  
NOTE: ALL PAVING WITHIN THE EXISTING AND PROPOSED CITY RIGHT-OF-WAY SHALL CONFORM TO THE REQUIREMENTS OF THE DEPARTMENT OF ENGINEERING.  
NOTE: THE CONTRACTOR SHALL CONTACT THE DEPARTMENT OF ENGINEERING TO SCHEDULE A PRE-CONSTRUCTION MEETING TO REVIEW THE DEPARTMENTS CONSTRUCTION REQUIREMENTS, STAFF NOTIFICATION REQUIREMENTS, REQUIRED INSPECTIONS FOR CERTAIN STAGES OF THE WORK AND TO REVIEW THE AUTHORITY OF THE DEPARTMENT AS IT RELATES TO WORK WITHIN THE EXISTING AND PROPOSED CITY RIGHT-OF-WAY.  
NOTE: FINISHED FLOOR ELEVATIONS OF ALL STRUCTURES SHALL BE NO LESS THAN 2' ABOVE ANY ADJACENT 100 YEAR LOCAL OR REGIONAL FLOOD ELEVATION (WHICHEVER IS GREATER).  
NOTE: ALL SUB-SURFACE DRAINS SHALL BE DOUBLE WALL HANCORE HI-Q OR EQUIVALENT.

EARTHWORK:

- EXCAVATION
  - Excavated material that is suitable may be used for fills. All unsuitable material and all surplus excavated material not required shall be removed from the site.
  - Provide and place any additional fill material from offsite as may be necessary to produce the grades required on plans. Fill obtained from offsite shall be of quality as specified for fills herein and the source approved by the Developer. It will be the responsibility of the Contractor for any costs for fill needed.
- REMOVAL OF TREES
  - All trees and stumps from area to be occupied by a road surface area and building pad. Trees and stumps shall not be buried on site.
- PROTECTION OF TREES
  - The Contractor shall, at the direction of the Developer, endeavor to save and protect trees of value and worth which do not impair construction of improvements as designed.
  - In the event cut or fill exceeds 0.5 foot over the root area, the Developer shall be consulted with respect of protective measure to be taken, if any, to preserve such trees.
- REMOVAL OF TOPSOIL
  - All topsoil shall be removed from all areas to be excavated. Topsoil should be stored at a location where it will not interfere with construction operations. The topsoil shall be free of debris and stones.
- UTILITIES
  - Rules and regulation governing the respective utility shall be observed in executing all work under this section.
  - It shall be the responsibility of the Contractor to determine the location of existing underground utilities 2 working days prior to commencing work. For utility locations to be marked call Toll Free 1-800-382-5544 within Indiana or 1-800-428-5200 outside Indiana.
- SITE GRADING
  - Do all cutting, filling, compacting of fills and rough grading required to bring entire project area to subgrade as shown on the drawing.
  - The total amount of fill shall not exceed 0.05 feet above established subgrade. All other areas shall not exceed 0.05 feet plus or minus the established grade. Provide rounding at top and bottom of banks and other breaks in grade.
  - The Engineer shall be notified when the Contractor has reached the tolerance as stated above, so that field measurements and spot elevations can be verified by the Engineer. The Contractor shall not remove his equipment from the site until the Engineer has verified that the job meets the above tolerance.

FORM\EARHTWRK




EMERGENCY SPILLWAY  
LAKE #2  
403-TG-SCALE

"HOLEY MOLEY"  
SAYS:  
CAUTION  
LOCATION OF ALL EXISTING UNDERGROUND UTILITIES SHOWN ON THIS PLAN ARE BASED UPON ABOVE GROUND EVIDENCE (INCORPORATED BUT NOT LIMITED TO, MONOLITHS, INLETS, VALVES, & MARKS MADE UPON THE GROUND BY OTHERS) AND ARE SPECULATIVE IN NATURE. THERE MAY ALSO BE OTHER UNKNOWN EXISTING UTILITIES WHICH THERE IS NO ABOVE GROUND EVIDENCE FOR OR WHICH NO ABOVE GROUND EVIDENCE WAS OBSERVED. THE EXACT LOCATIONS OF SAID EXISTING UNDERGROUND UTILITIES SHOULD BE VERIFIED BY THE CONTRACTOR PRIOR TO ANY AND ALL CONSTRUCTION.

1-800-382-5544  
CALL TOLL FREE  
1-800-428-5200  
FOR CALLS OUTSIDE OF INDIANA

DRAWN BY: TWF  
CHECKED BY: BKR  
SHEET NO. C201  
S. & A. JOB NO. 52645

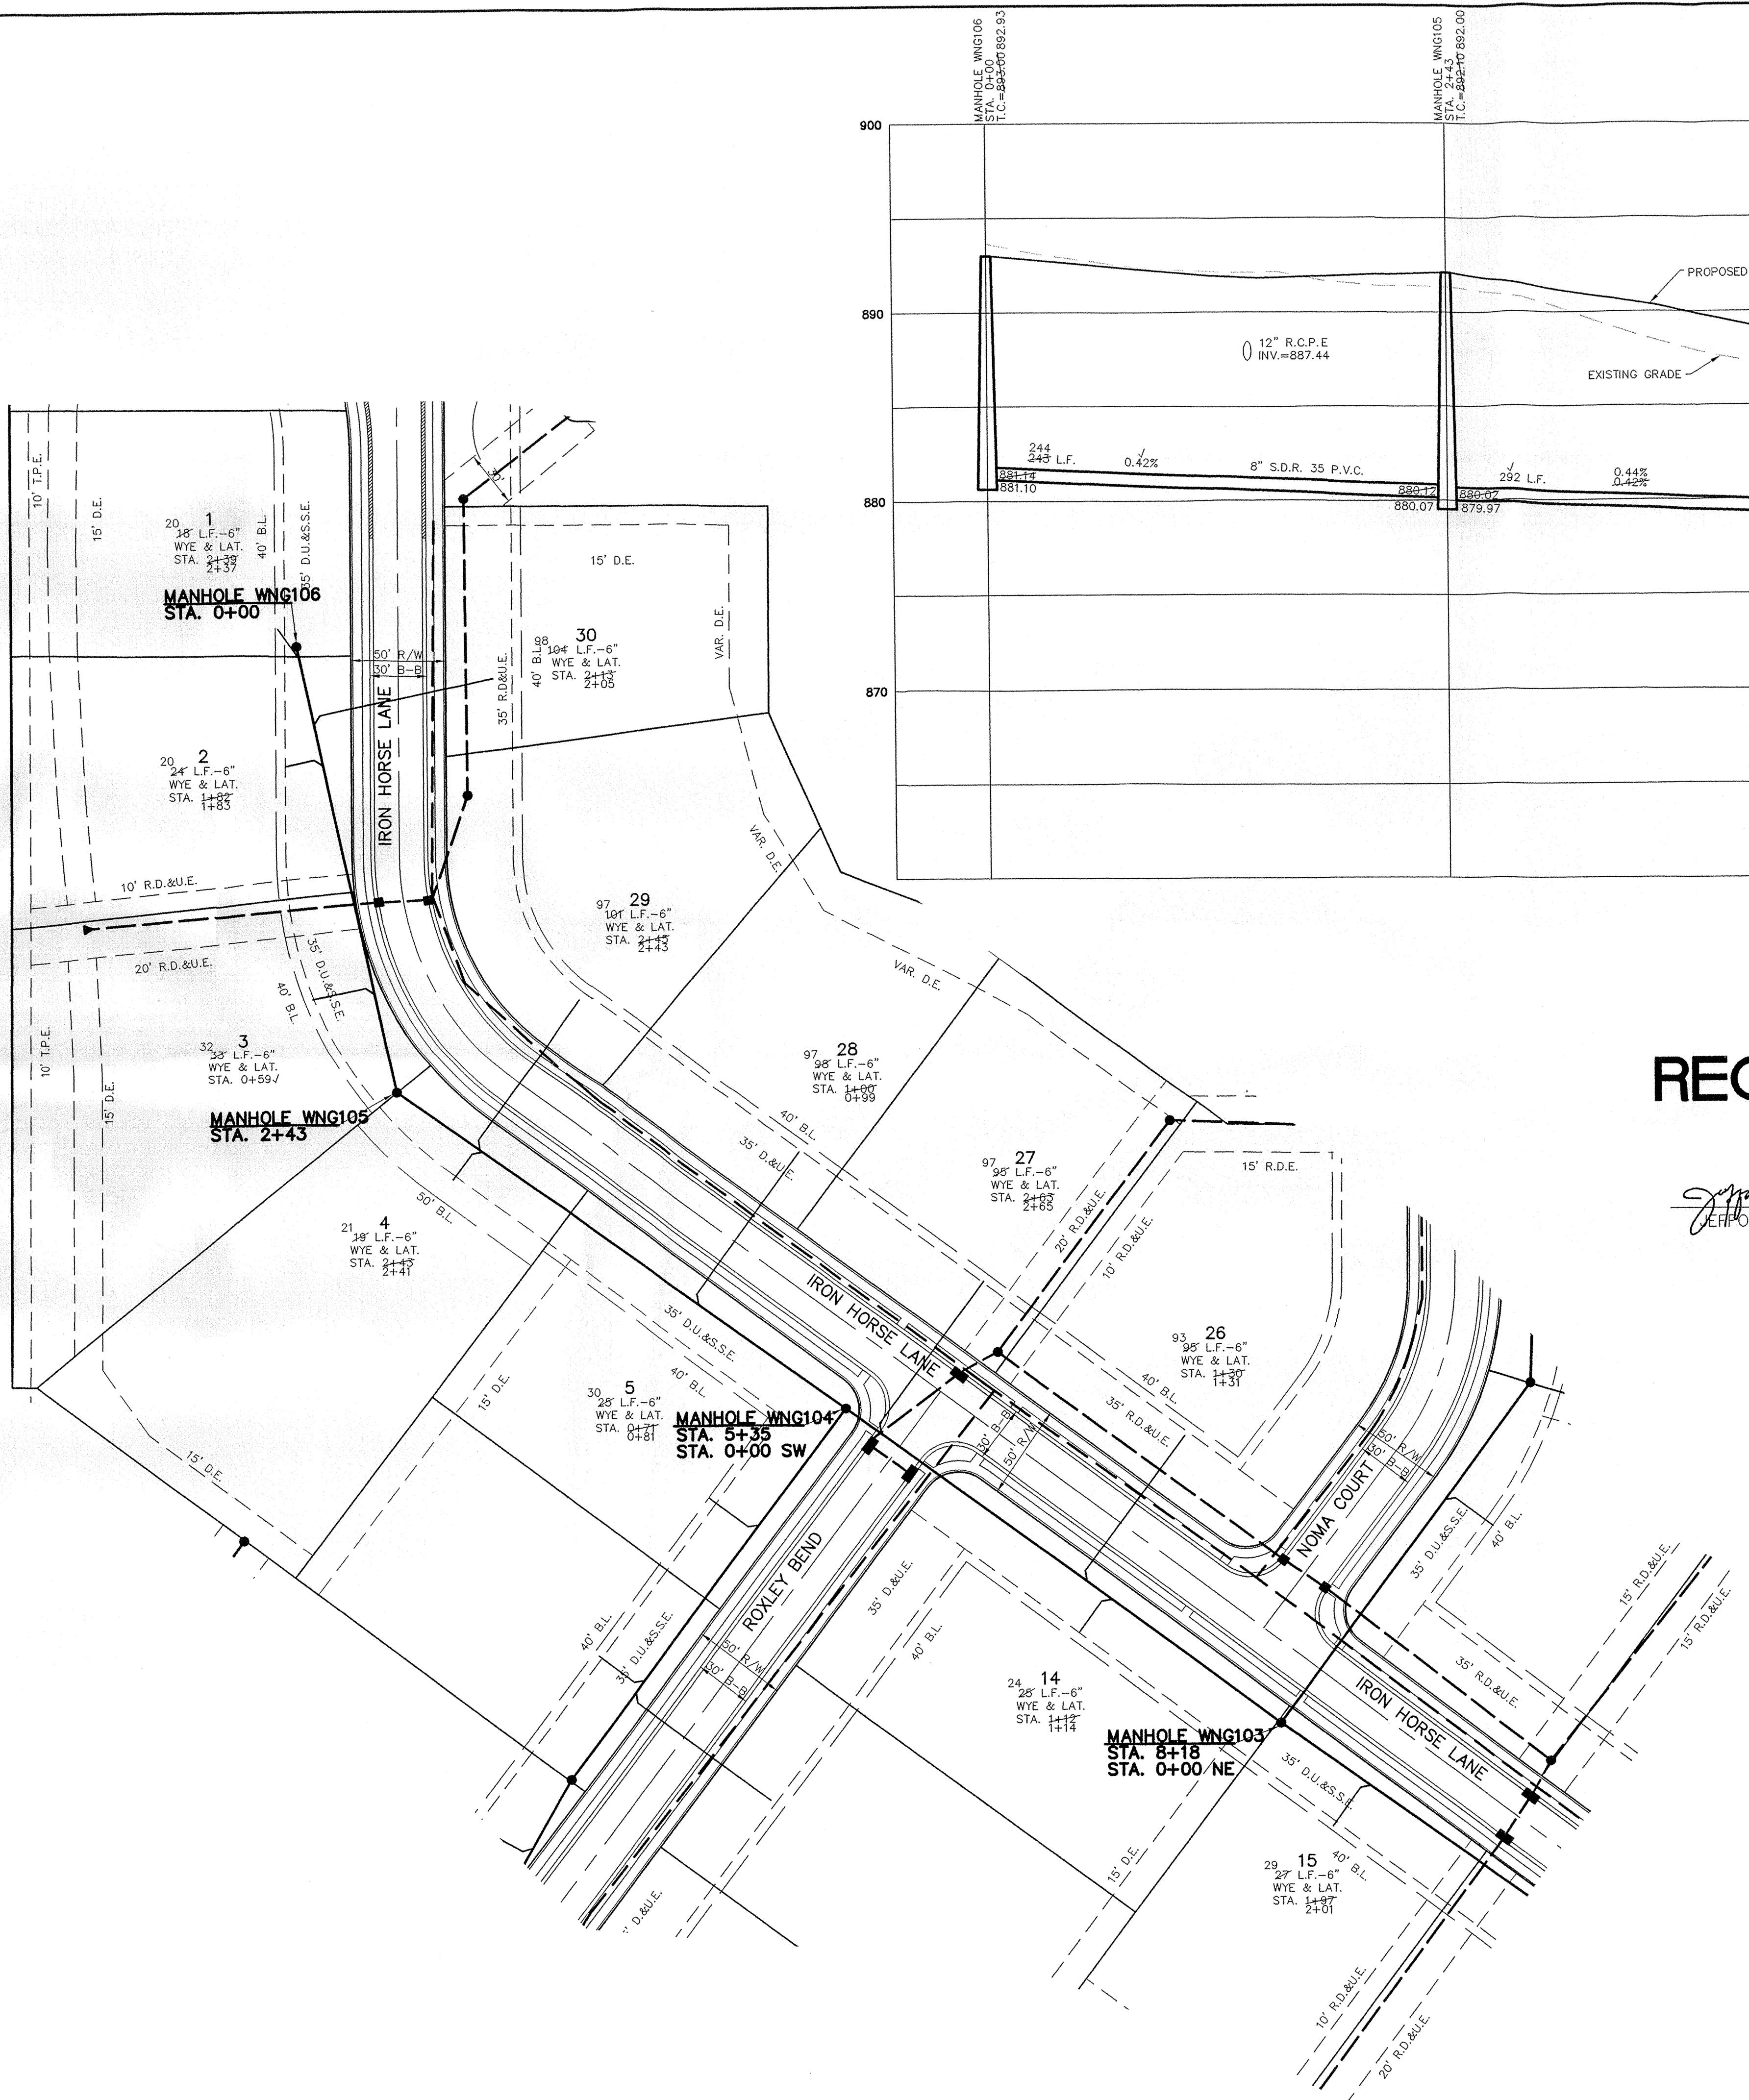

## RECORD DRAWING

*Jeffory W. Darling*  
JEFFORY W. DARLING  
Registered Land Surveyor  
No. 900017



9/27/06

DATE



DENOTES FULL DEPTH GRANULAR BACKFILL

NOTE: THERE ARE TO BE NO WATER VALVES OR MANHOLES  
WITHIN THE PAVEMENT, CURBS, OR SIDEWALK.

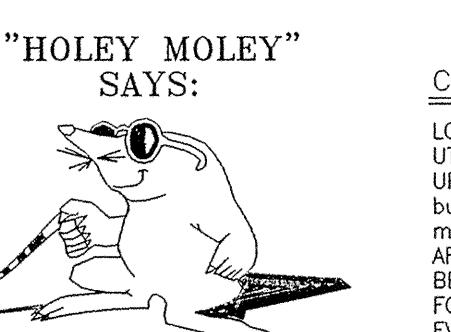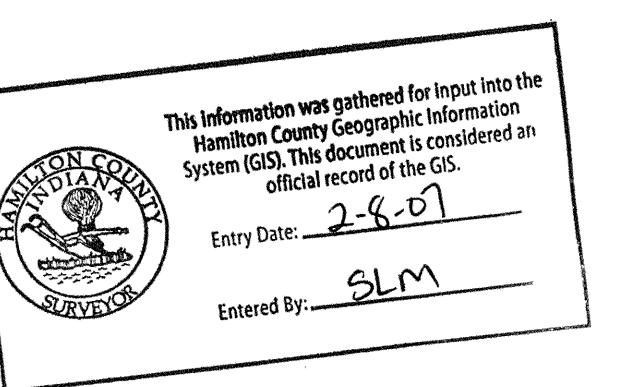

CAUTION  
LOCATION OF ALL EXISTING UNDERGROUND UTILITIES SHOWN ON THIS PLAN ARE BASED UPON ABOVE GROUND EVIDENCE (INCLUDING, BUT NOT LIMITED TO, MANHOLES, INLETS, VALVES, & MARKS MADE UPON THE GROUND BY OTHERS) AND ARE NOT A SUBSTITUTE FOR A PROFESSIONAL SURVEY. ALSO, OTHER EXISTING UNDERGROUND UTILITIES FOR WHICH THERE IS NO ABOVE GROUND EVIDENCE OR FOR WHICH THE ABOVE GROUND EVIDENCE WAS OBSERVED, THE EXACT LOCATIONS OF WHICH ARE UNKNOWN, MAY EXIST. THESE UTILITIES SHOULD BE VERIFIED BY THE CONTRACTOR PRIOR TO ANY AND ALL CONSTRUCTION.

1-800-382-5544  
CALL TOLL FREE  
1-800-428-5200  
FOR CALLS OUTSIDE OF INDIANA


### SANITARY PLAN & PROFILES

### WINDSOR GROVE II

HAMILTON COUNTY, INDIANA  
CARMEL  
DRAWN BY: TWF  
CHECKED BY: BKR  
SHEET NO.  
C500  
S & A JOB NO.  
52645

CERTIFIED: 1/3/06

CRM	ASBULLS
KMC	JAMES D. BINEHART REGISTERED PROFESSIONAL ENGINEER No. 10200495 STATE OF INDIANA
AAA	5/27/06 REVISED PER DEVELOPER
AAA	5/27/06 REVISED PER AGENCY COMMENTS
AAA	5/31/06 REVISED PER DIR. ANALYSIS
AAA	12/13/05 REVISED PER TAC COMMENTS
KMC	DATE MARK
	REVISIONS BY

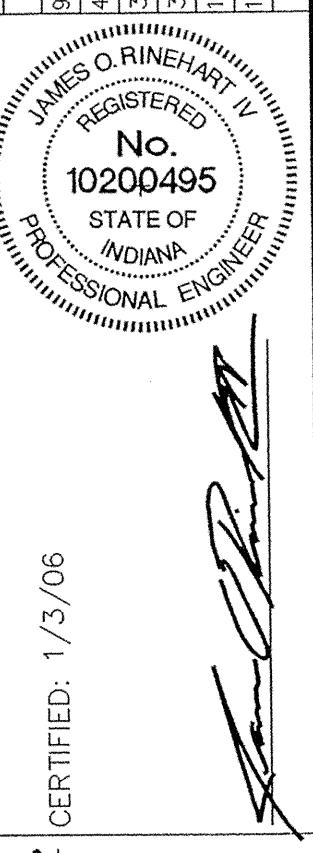

9/27/06  
REVISED PER DEVELOPER

5/27/06  
REVISED PER AGENCY COMMENTS


5/31/06  
REVISED PER DIR. ANALYSIS

12/13/05  
REVISED PER TAC COMMENTS

DATE MARK

REVISIONS BY


BY

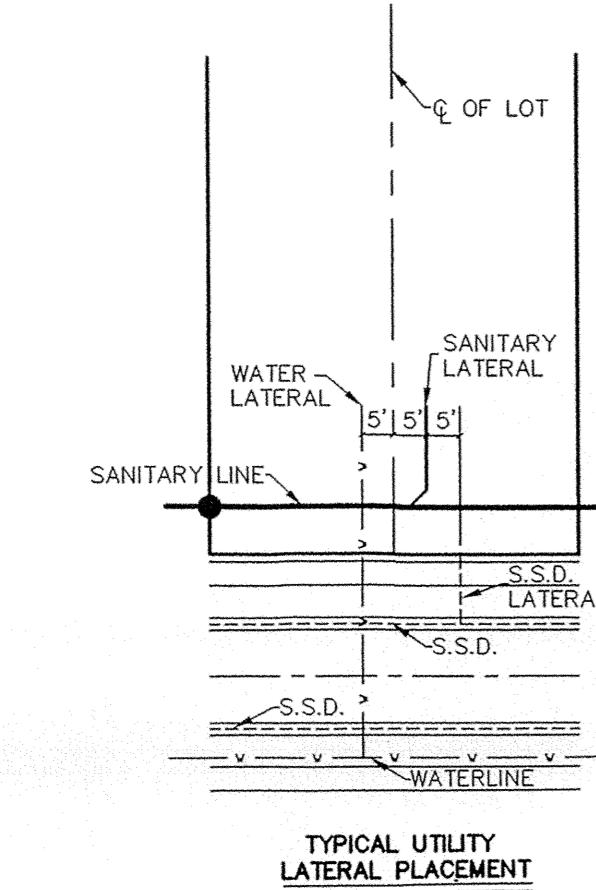

NOTE: THERE ARE TO BE NO WATER VALVES OR MANHOLES WITHIN THE PAVEMENT, CURBS, OR SIDEWALK.

DENOTES FULL DEPTH GRANULAR BACKFILL

NOTE:  
CONTRACTOR TO VERIFY ALL EXISTING  
UTILITES UPON CONSTRUCTION

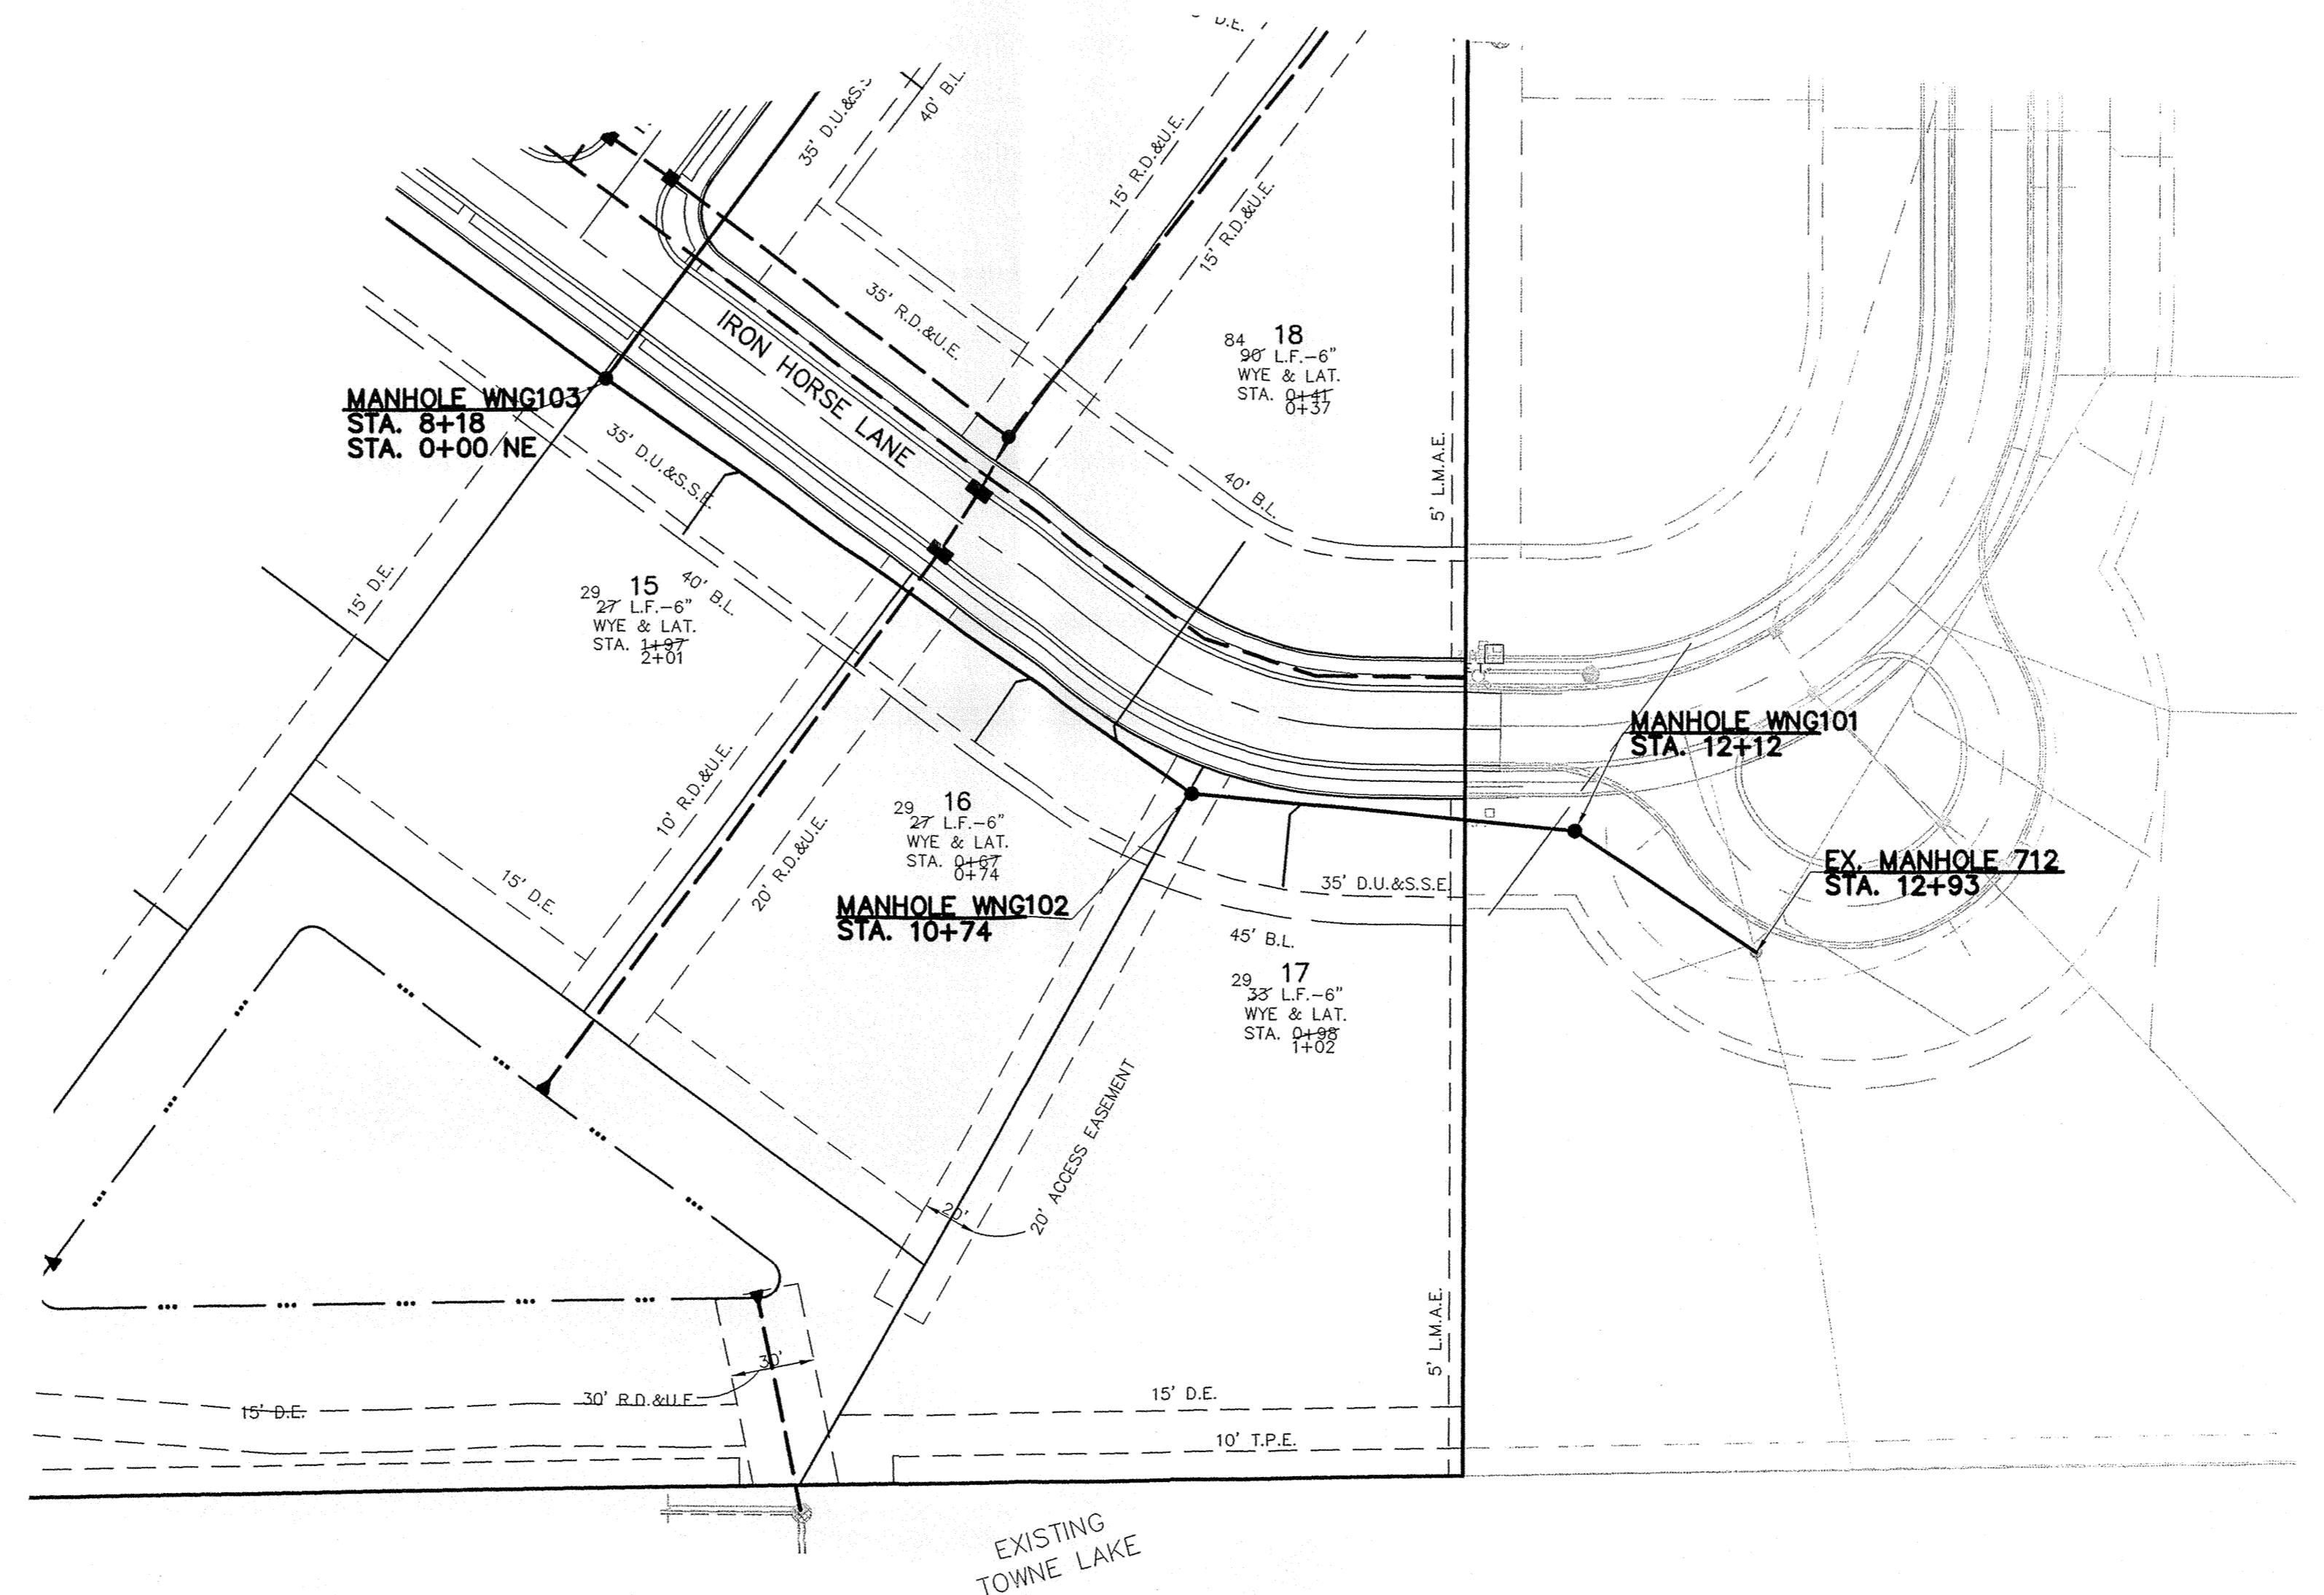

SCALE: 1" = 50'

JAMES O'BRIEN HART, P.R.E.  
REGISTERED PROFESSIONAL ENGINEER  
No. 10200495  
STATE OF INDIANA  
KMC

CRM  
KMC  
AAA  
AAA  
AAA  
AAA  
KMC



REVISIONS  
DATE: MARK BY:

## RECORD DRAWING


*Jeff W Darling*  
JEFF W. DARLING  
Registered Land Surveyor  
No. 900017



9/27/06

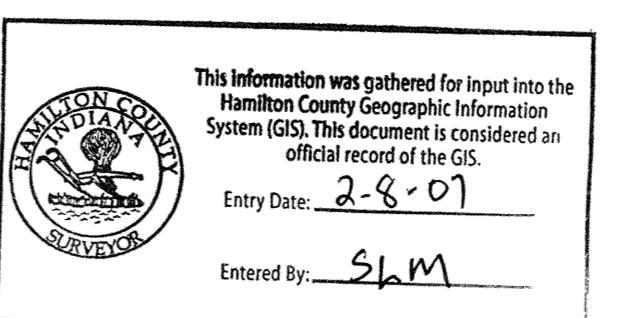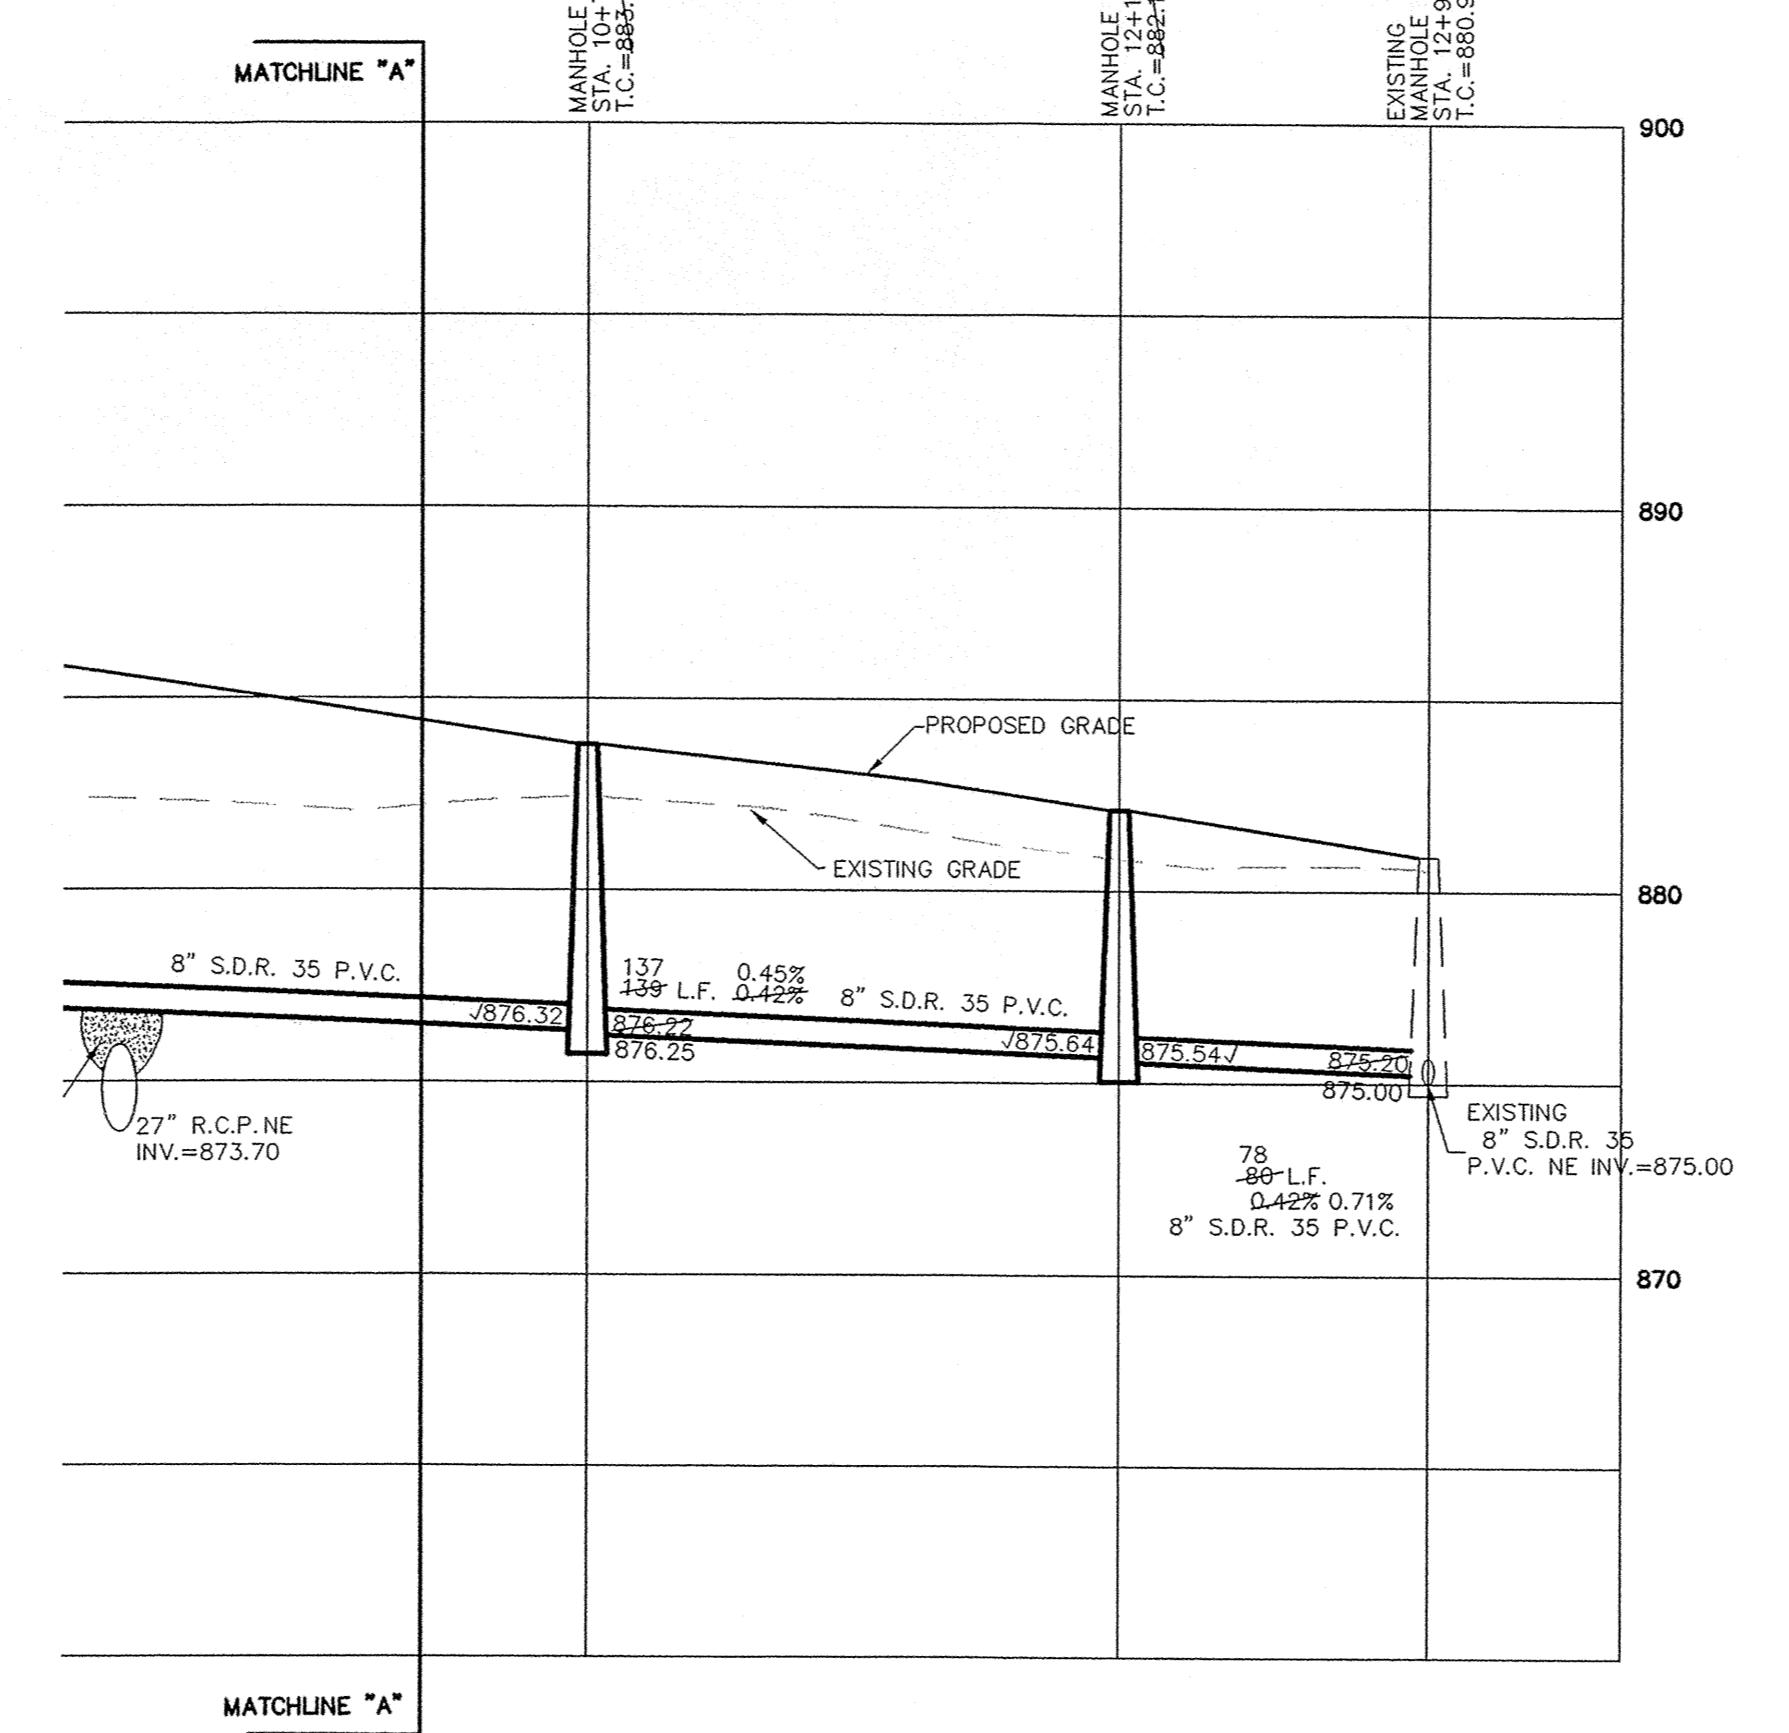

This information was gathered for input into the Hamilton County Geographic Information System (GIS). This document is considered an official record of the GIS.  
Entry Date: 2-8-01  
Entered By: S.M.

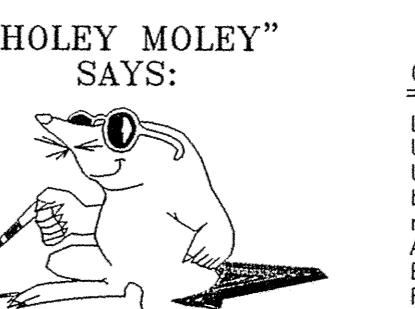

"HOLEY MOLEY"  
SAYS:  
1-800-382-5544  
CALL TOLL FREE  
1-800-428-5200  
FOR CALLS OUTSIDE OF INDIANA

LOCATION OF ALL EXISTING UNDERGROUND UTILITIES SHOWN ON THIS PLAN ARE BASED UPON ABOVE GROUND EVIDENCE, (INCLUDING BUT NOT LIMITED TO, MANHOLES, INLETS, VALVES, & MARKS MADE UPON THE GROUND BY OTHERS) AND ARE SPECIFIED IN THIS DRAWING. THERE MAY ALSO BE OTHER EXISTING UNDERGROUND UTILITIES FOR WHICH THERE IS NO ABOVE GROUND EVIDENCE OR FOR WHICH NO ABOVE GROUND EVIDENCE WAS OBSERVED. THE EXACT LOCATIONS OF SUCH EXISTING UNDERGROUND UTILITIES SHOULD BE VERIFIED BY THE CONTRACTOR PRIOR TO ANY AND ALL CONSTRUCTION.

CAUTION

## SANITARY PLAN & PROFILES



STOEPPELWERTH & ASSOCIATES, INC.  
CONSULTING ENGINEERS & LAND SURVEYORS  
9940 Allisonville Rd., Fishers, IN 46038-2005  
Phone: (317) 849-5935 Fax: (317) 849-5942  
Toll Free: (800) 728-6917


HAMILTON COUNTY, INDIANA

WINDSOR GROVE II

CARMEL

DRAWN BY: TWF  
CHECKED BY: BKR  
SHEET NO. C501  
S. & A. JOB NO. 52645

52645

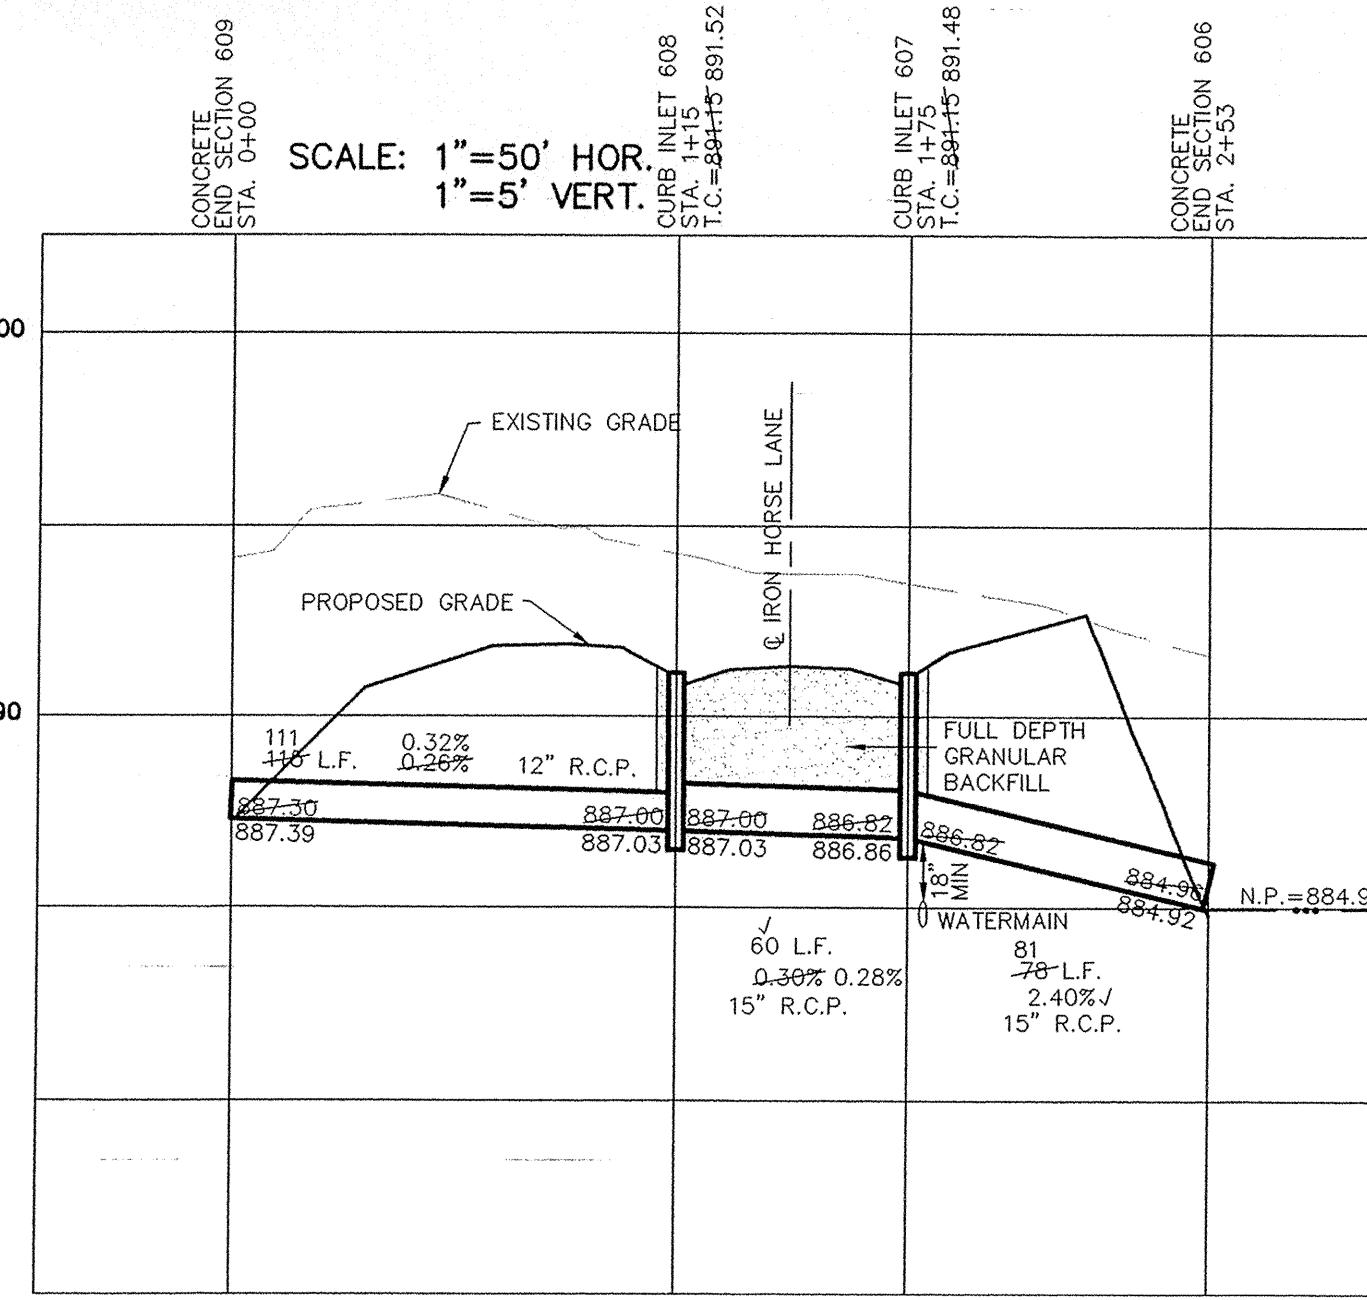


# **RECORD DRAWING**


Jeffrey W Darling 9/2  
JEFFORY W. DARLING DA  
Registered Land Surveyor  
No. 900017

A circular registration stamp with a double concentric dotted border. The outer ring contains the text "LAND SURVEYOR" at the bottom and "STATE OF INDIANA" at the top. The inner circle contains "REGISTRATION" at the top, "No." in the center, and "900017" below it. The name "JEFFORY W. DARLING" is written along the top edge of the inner circle.

SCALE: 1"=50' HOR.  
1"=5' VERT.

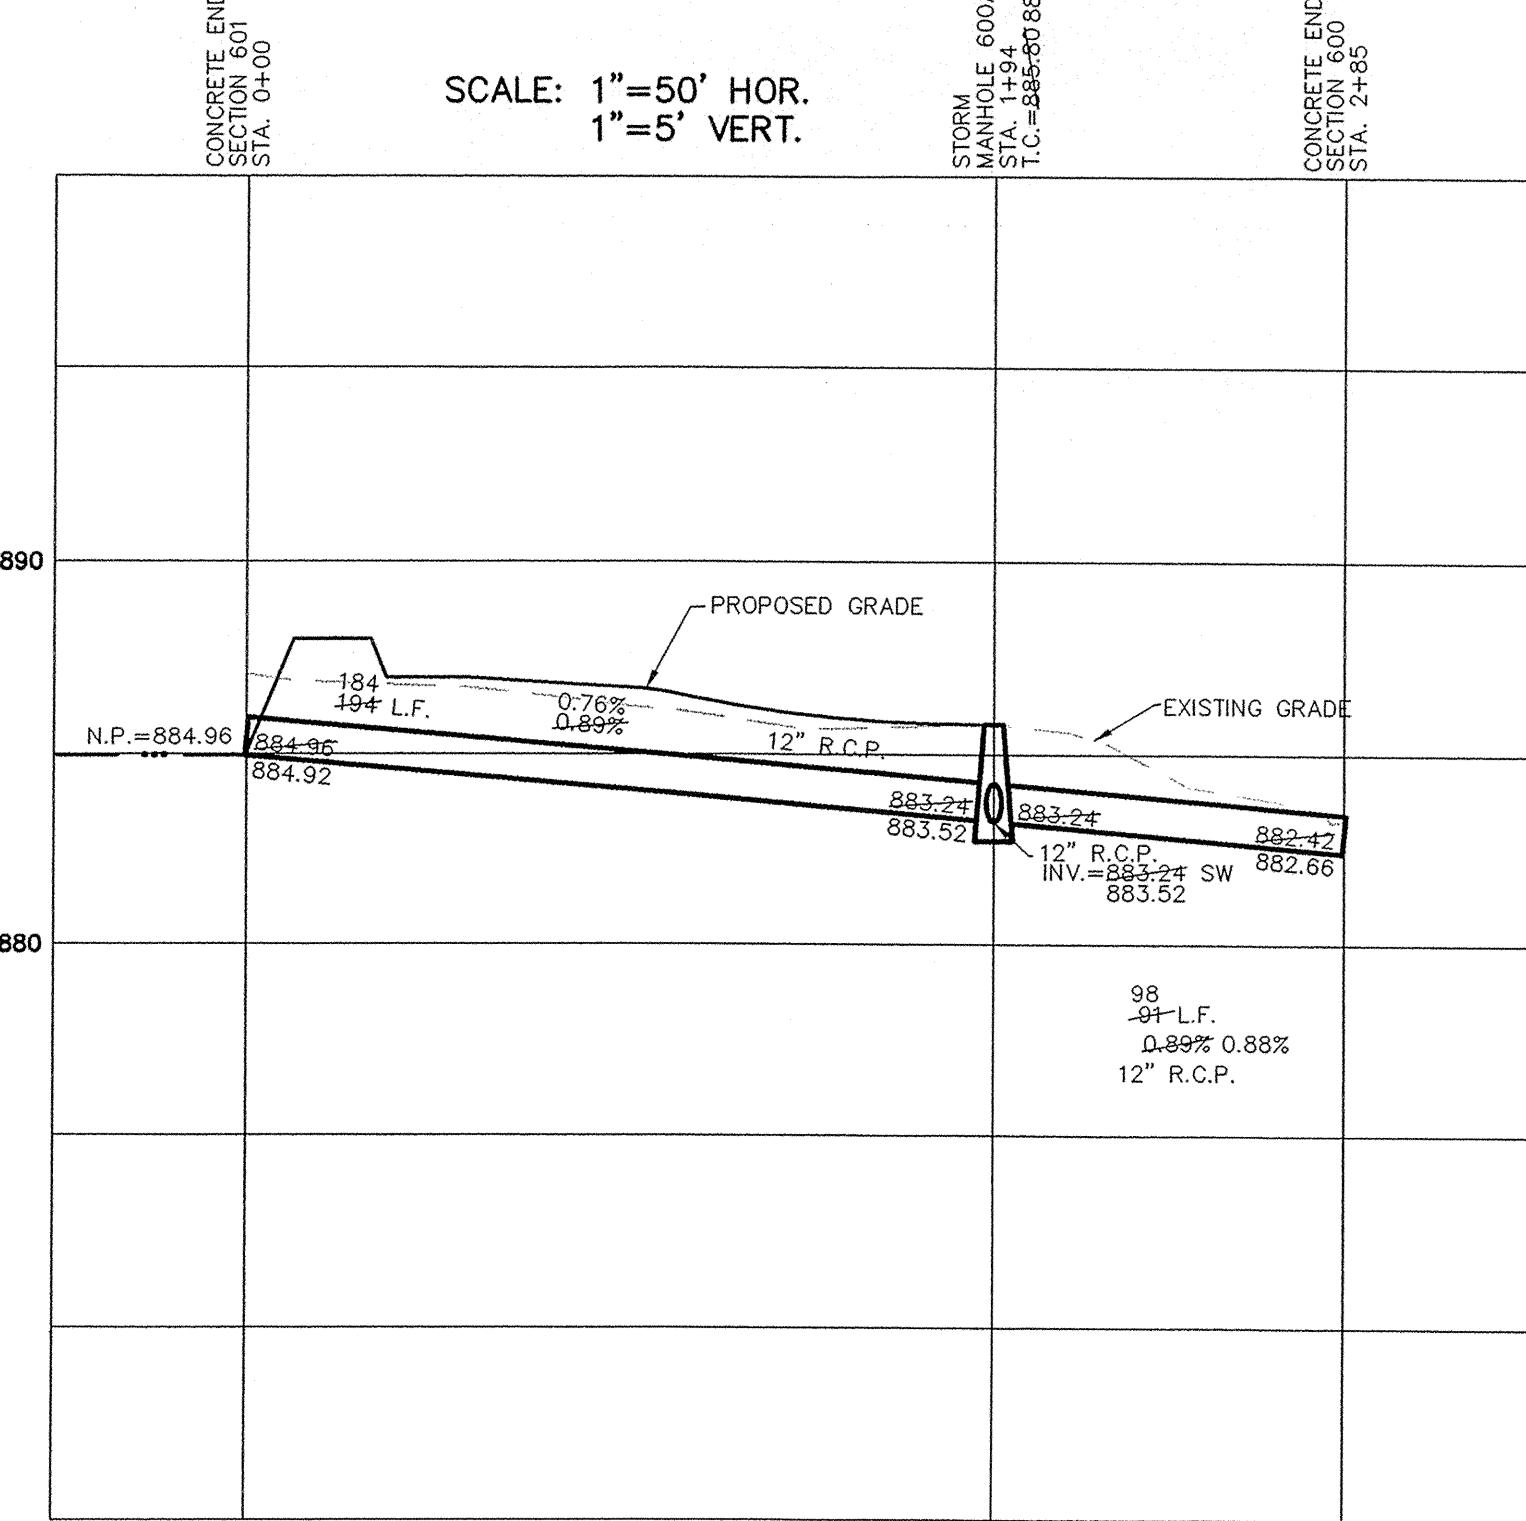

NOTE: ALL CASTINGS SHALL BE LABELED  
"DUMP NO WASTE—DRAINS TO WATERWAY".

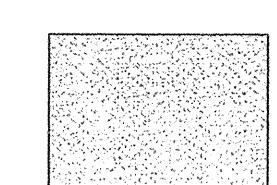

DENOTES FULL DEPTH GRANULAR BACKFILL

"HOLEY MOLEY"  
SAYS:

800-382-5544

CALL TOLL FREE  
800-428-5200

CALLS OUTSIDE OF INDIANA  
317-571-2648

CALL CARMEL UTILITIES  
(FOR WATER MAIN LOCATIONS)

CAUTION

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1

—

YARD INLET 605  
STA. 0+00  
T.C. = 889-00

CONCRETE  
END SECTION 604  
STA. 0+87

SCALE: 1"=50' H.O.F.  
1"=5' VERT.

EXISTING GRADE

PROPOSED GRADE

885.22

885.41

884.96

885.00

N.P.=884.96

83  
87 L.F.,  
0.30% 0.49%  
12" R.C.P.

A circular seal for Hamilton County, Indiana Surveyor. The outer ring contains the text "HAMILTON COUNTY" at the top and "INDIANA" at the bottom. The center features a torch above crossed surveying tools (a compass and a chain) with the word "SURVEYOR" below them.

This information was gathered for input into the Hamilton County Geographic Information System (GIS). This document is considered an official record of the GIS.

Entry Date: 2-8-07

Entered By: SLM

CONCRETE END SECTION 615 STA. 0+00

CURB INLET 614 STA. 1+42 T.C.=891.15 891.21

CURB INLET 613 STA. 1+72 T.C.=891.15 891.16

STORM MANHOLE 612 STA. 2+24 T.C.=892.70 893.16

STORM MANHOLE 611 STA. 3+83 T.C.=893.00 892.65

CONCRETE END SECTION 610 STA. 4+53

SCALE: 1"=50' HOR.  
1"=5' VERT.

EXISTING GRADE  
FULL DEPTH GRANULAR BACKFILL  
IRON HORSE LANE  
WATERMAIN  
PROPOSED GRADE

154' L.F. 1.94%  
142' L.F. 0.35%  
12" R.C.P.  
887.90  
890.58  
887.41  
887.60  
887.43  
18" MIN  
157' L.F. 0.34%  
159' L.F. 0.30%  
18" R.C.P.  
887.16  
887.22  
886.69  
886.68  
886.69  
886.68  
N.P.=884.96

887.41  
887.43  
887.32  
887.32  
887.16  
887.16  
886.69  
886.68  
884.96  
884.99

0.57% 0.30%  
15" R.C.P.  
8" S.D.R. 35 P.V.C.  
INV.=880.56 0

✓ 30' L.F.  
59' L.F.  
0.30% 0.36%  
18" R.C.P.

76' 70' L.F.  
2.45% 2.22%  
18" R.C.P.

**ANSWER** The answer is 1000. The area of the rectangle is 1000 square centimeters.

CAUTION

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1

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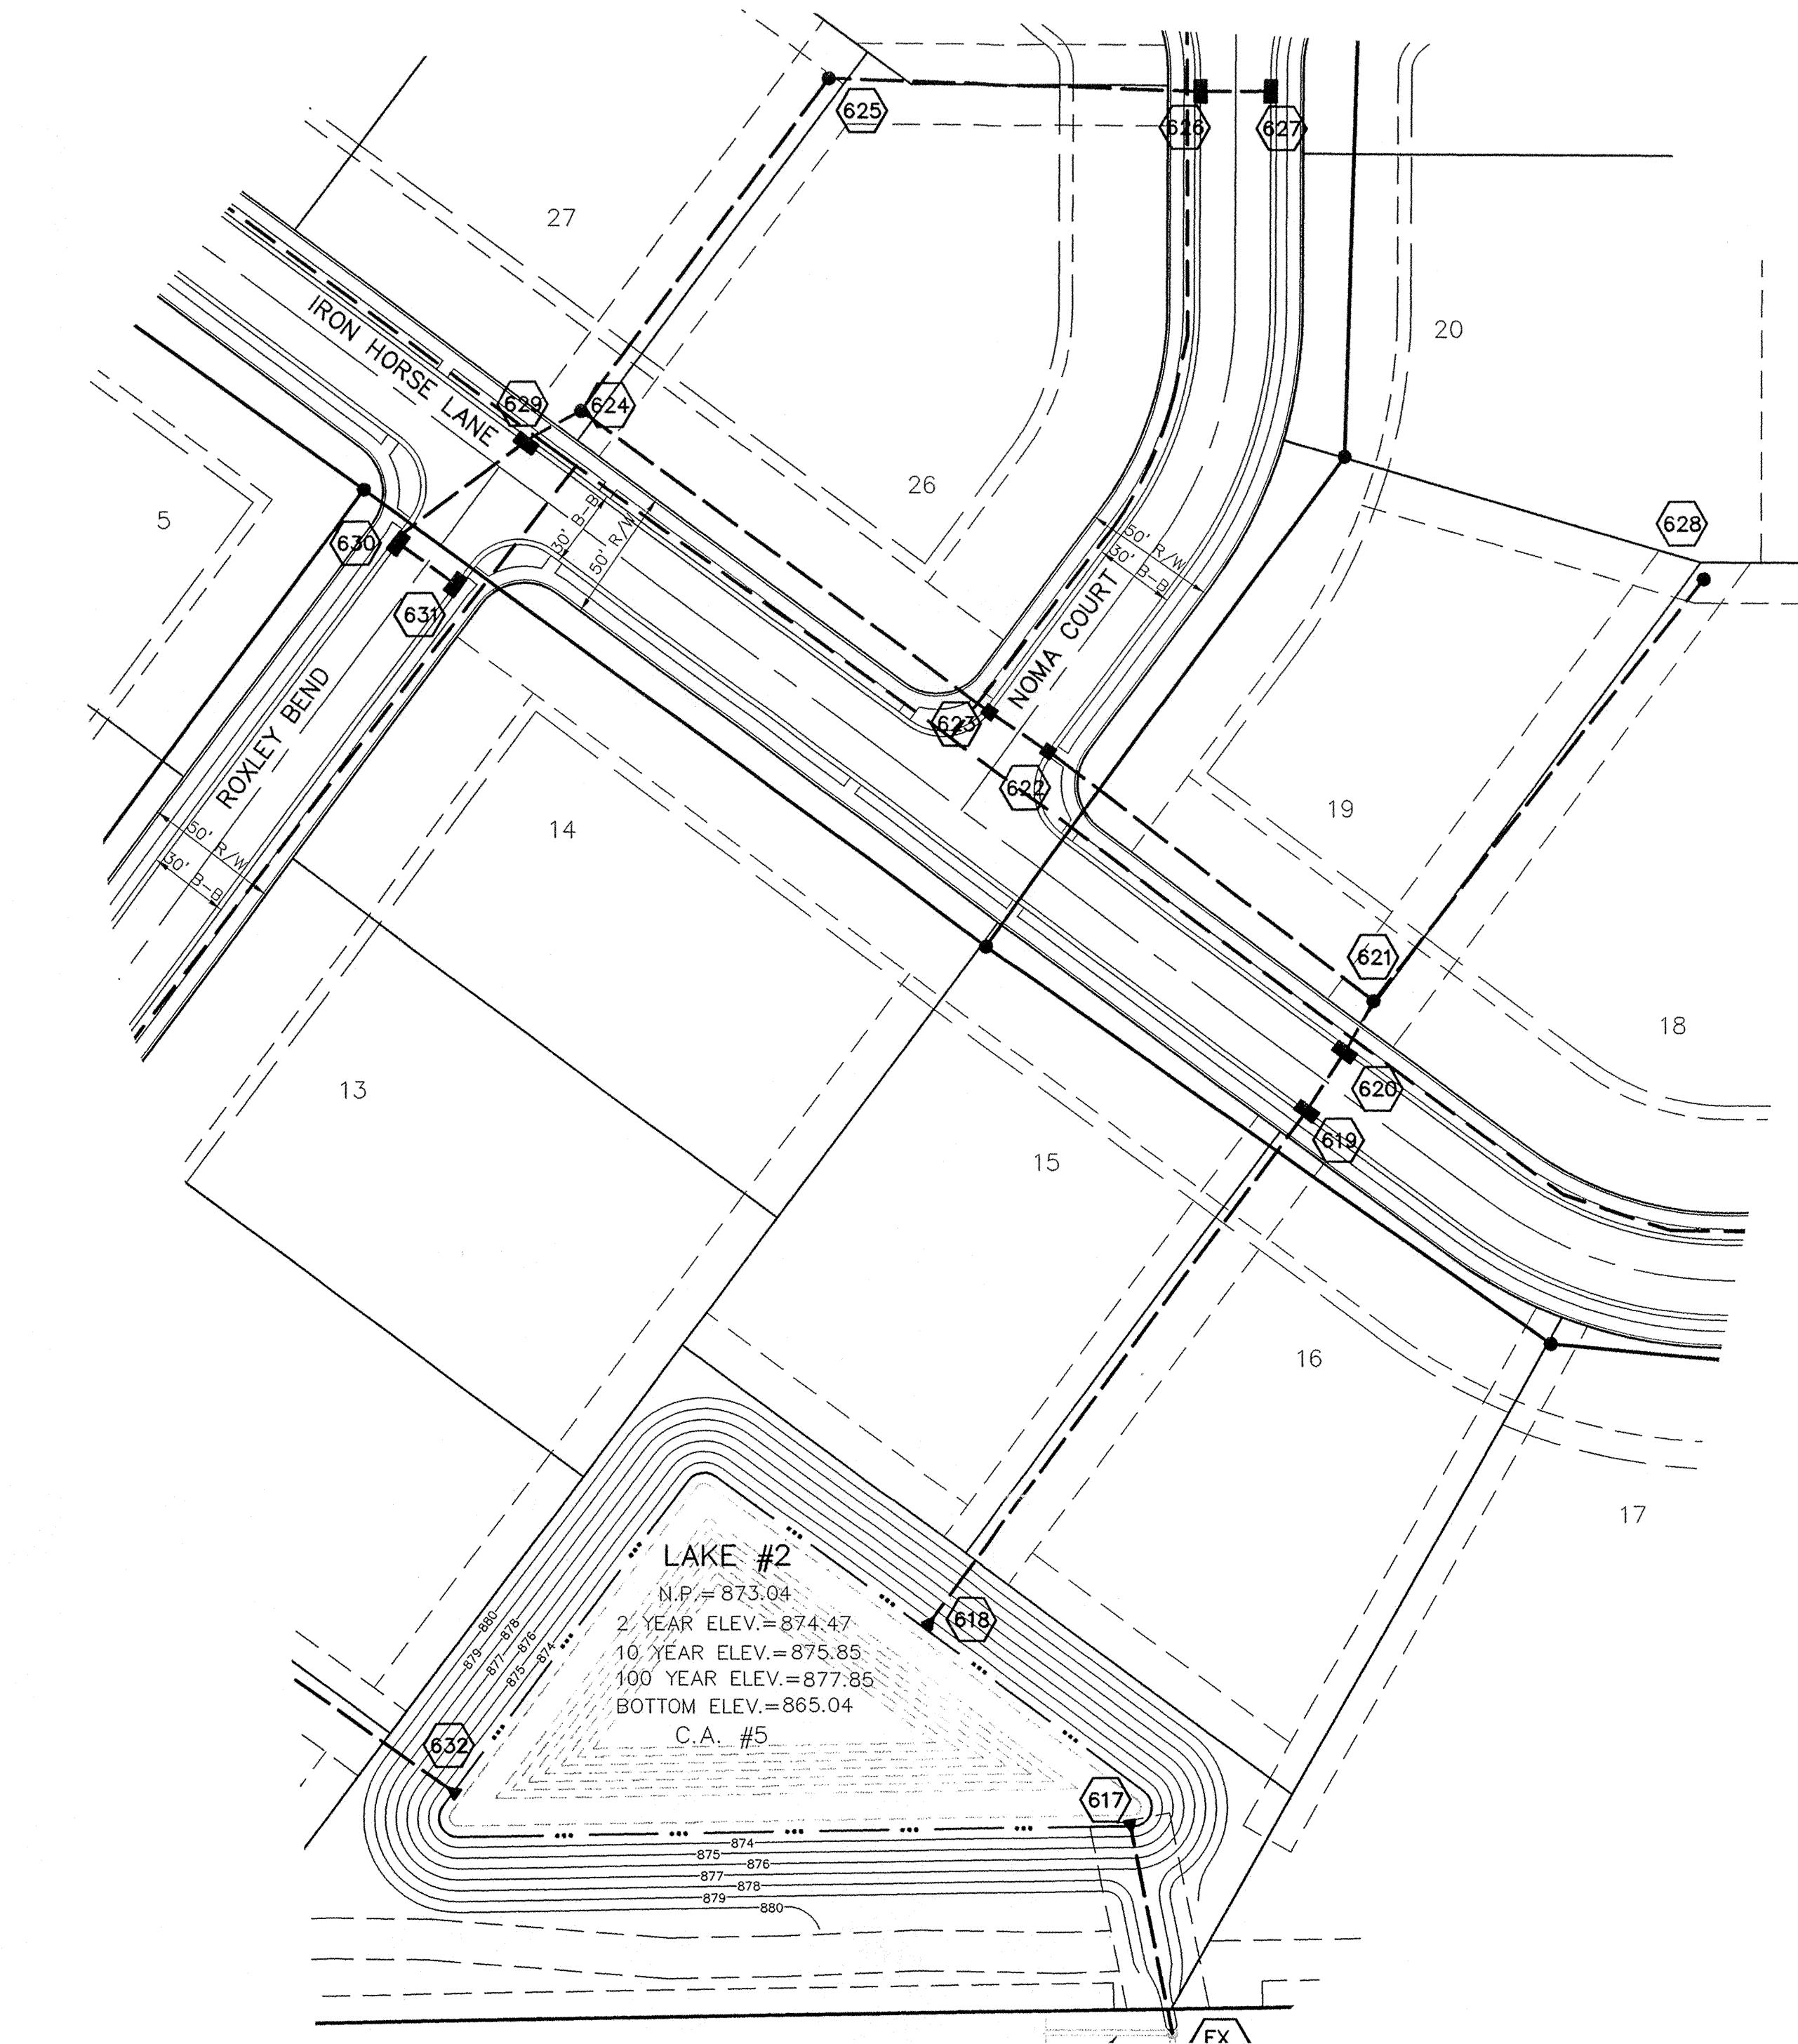
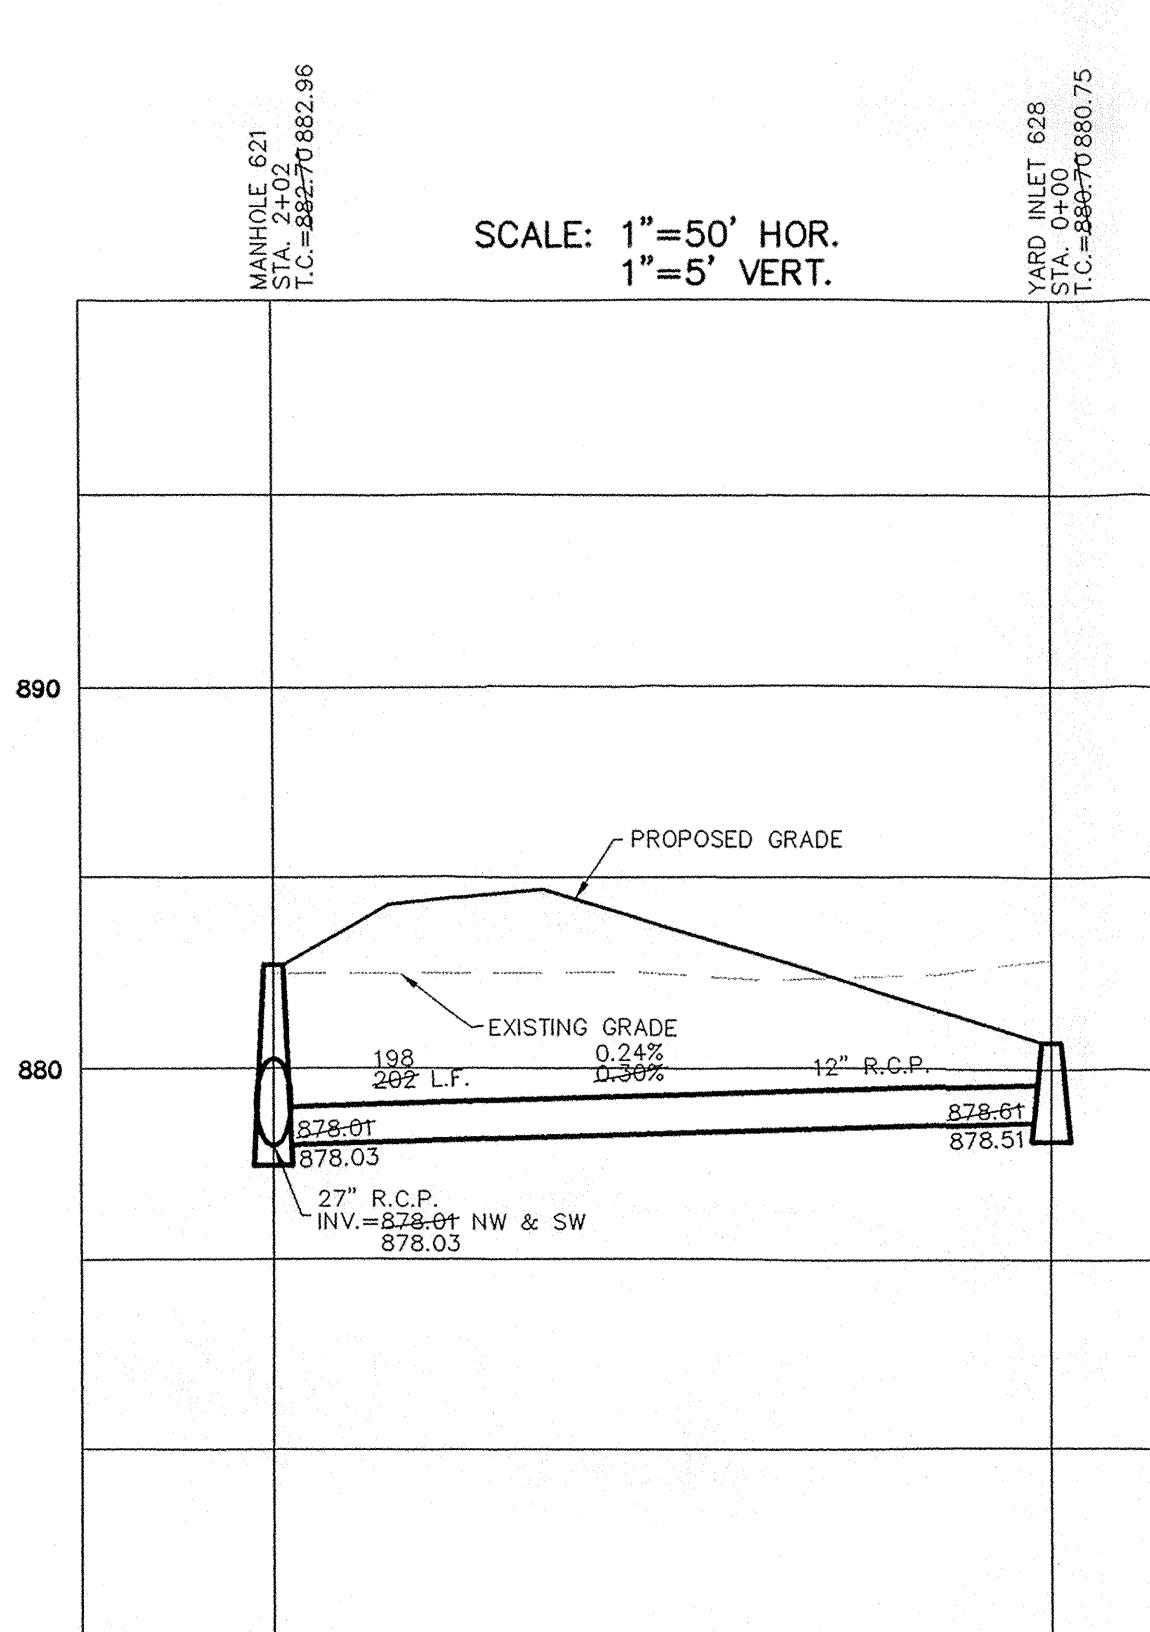
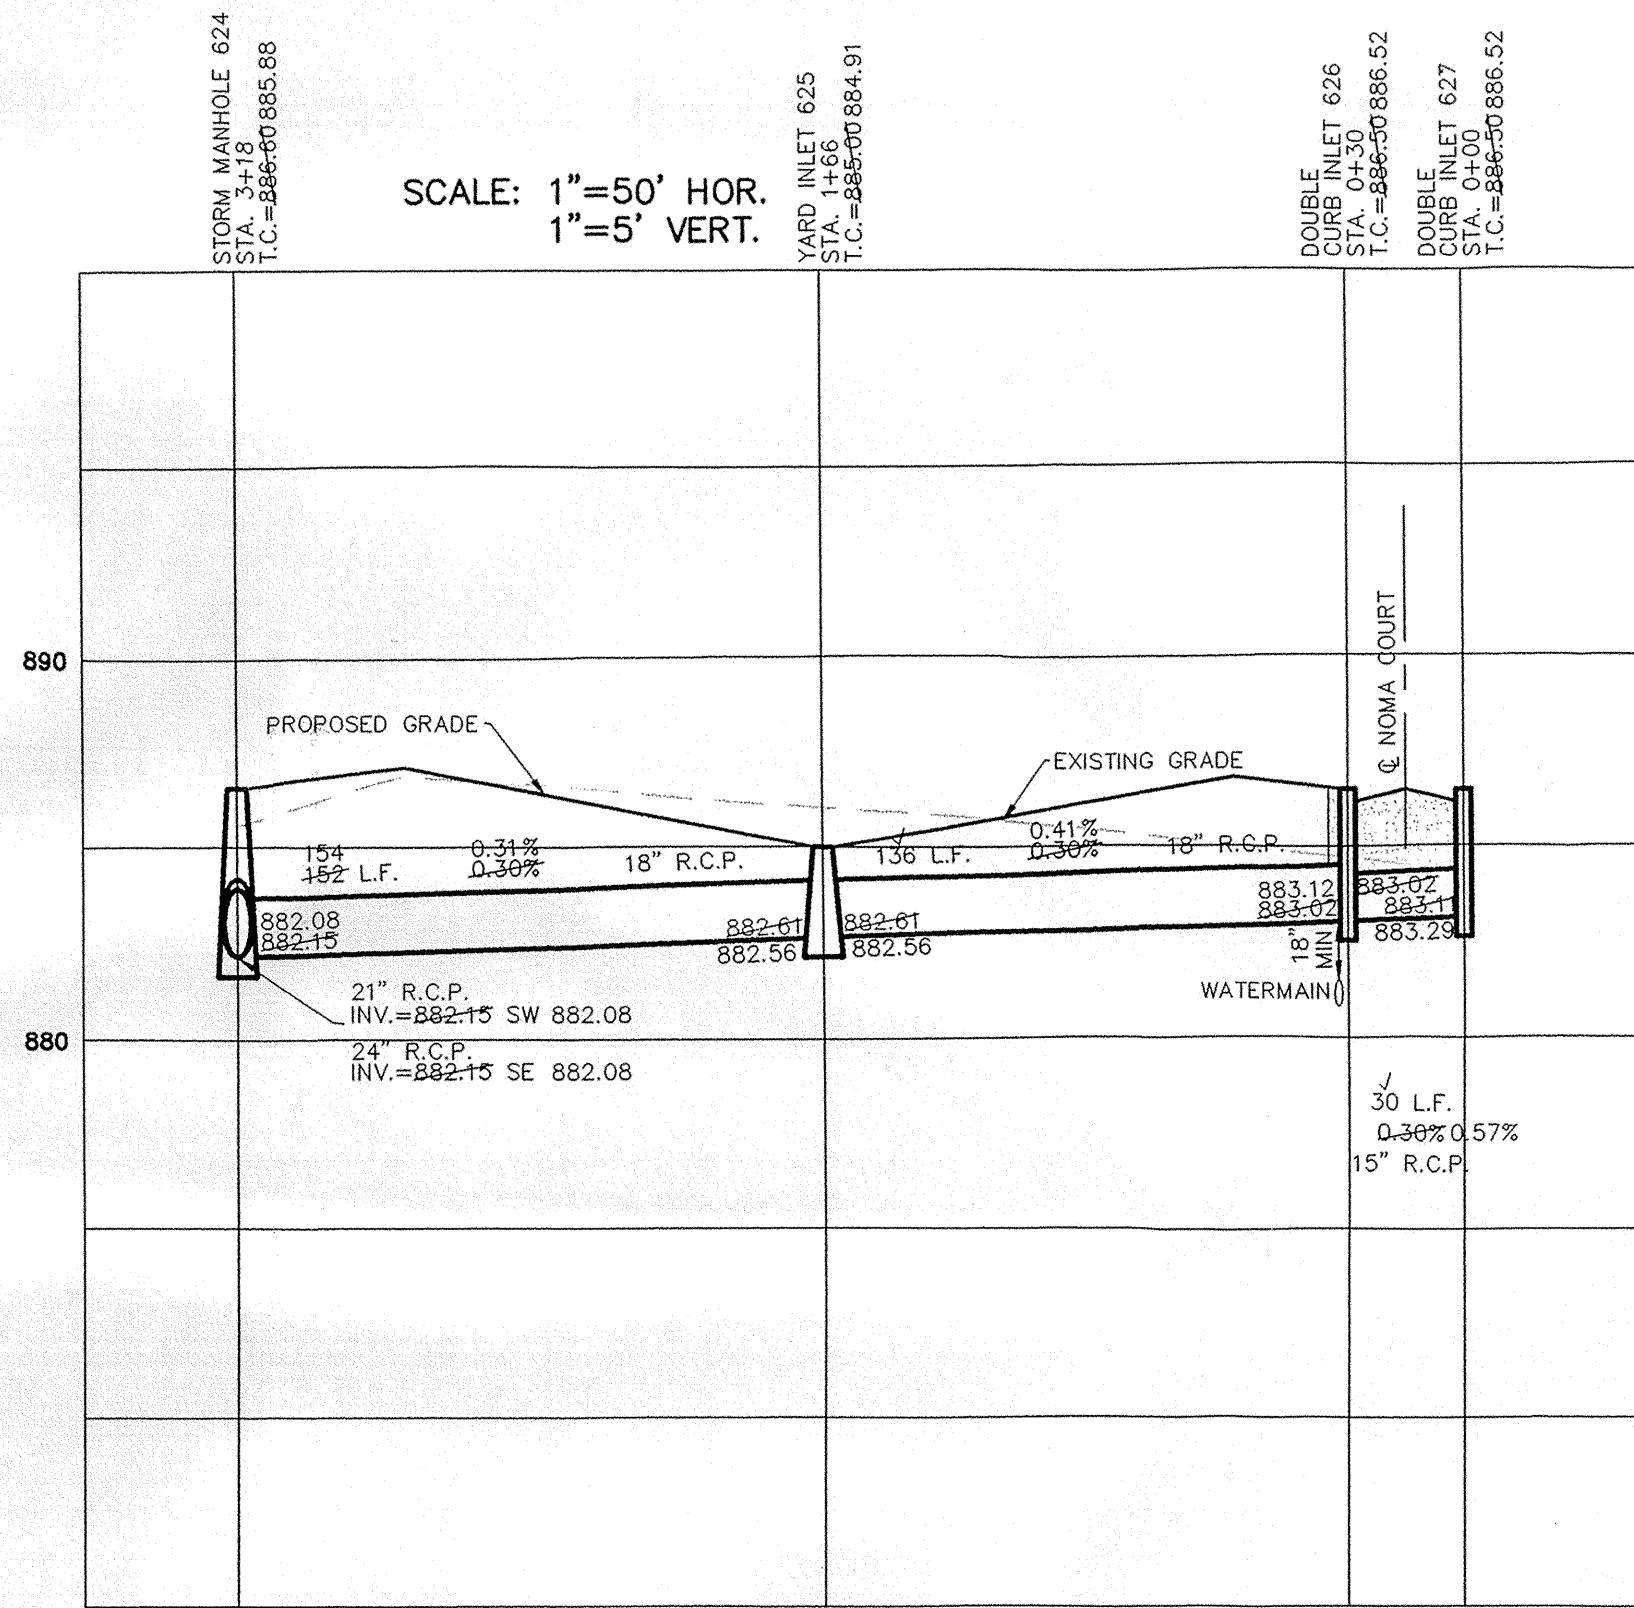
9/27/06	AS BUILT	CRM
6/6/06	REVISED TC FOR INLET 605 ▲	KMC
4/14/06	REVISED PER DEVELOPER	KMC
3/1/06	REVISED PER DIRT ANALYSIS	AAA
1/31/06	REVISED PER TAC COMMENTS	AAA

**CERTIFIED: 1/3/06**

The stamp is circular with a decorative border. The outer ring contains the text "JAMES O. RINEHART IV" at the top and "PROFESSIONAL ENGINEER" at the bottom. The inner circle contains "REGISTERED" at the top, "No." in the center, and "10200495" below it. At the bottom, it says "STATE OF" above "INDIANA". To the right of the stamp is a handwritten signature.

DENOTES FULL DEPTH GRANULAR BACKFILL


NOTE: ALL CASTINGS SHALL BE LABELED  
"DUMP NO WASTE—DRAINS TO WATERWAY".



# RECORD DRAWING

*Jeffrey W Darling*  
JEFFORY W. DARLING  
Registered Land Surveyor  
No. 900017

A cartoon illustration of a white mouse with large ears and whiskers. The mouse is wearing dark sunglasses and holding a pencil in its front paws, appearing to write or draw. It has a small tuft of hair on its tail.

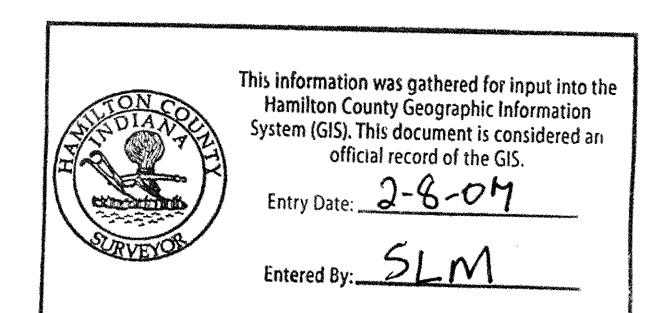

The seal is circular with a blue border containing the text "HAMILTON COUNTY INDIANA SURVEYOR". Inside the border is a landscape scene featuring a large tree, a river, and a bridge.

This information was gathered for input into the Hamilton County Geographic Information System (GIS). This document is considered an official record of the GIS.

Entry Date: 2-8-04

Entered By: SLM

AUTION

CATION OF ALL EXISTING UNDERGROUND UTILITIES SHOWN ON THIS PLAN ARE BASED UPON ABOVE GROUND EVIDENCE. (including, but not limited to, manholes, inlets, valves, & marks made upon the ground by others.) AND ARE SPECULATIVE IN NATURE. THERE MAY ALSO BE OTHER EXISITING UNDERGROUND UTILITIES FOR WHICH THERE IS NO ABOVE GROUND EVIDENCE OR FOR WHICH NO ABOVE GROUND EVIDENCE WAS OBSERVED. THE EXACT LOCATIONS OF SAID EXISTING UNDERGROUND UTILITIES SHOULD BE VERIFIED BY THE CONTRACTOR PRIOR TO ANY AND ALL CONSTRUCTION.

A cartoon illustration of a mole with a large nose and whiskers, wearing large, round sunglasses and holding a pencil. The mole is sitting at a desk, looking towards the right. The background is plain white.

**800-382-5544**  
**CALL TOLL FREE**

**800-428-5200**  
**CALLS OUTSIDE OF INDIANA**

**317-571-2648**  
**CALL CARMEL UTILITIES**  
**FOR WATER MAIN LOCATIONS)**

**800-428-5200**  
**CALLS OUTSIDE OF INDIANA**  
**317-571-2648**  
**CALL CARMEL UTILITIES**  
**OR WATER MAIN LOCATIONS)**

# WINDSOR GROVE II TORM PLAN & PROFILES

<b>NC.</b> <hr/> <b>RS</b>	CERTIFIED: 1/3/06 <hr/>	 		
		9/27/06	ASBUILTS	
		4/14/06	REVISED PER DEVELOPER	
		3/1/06	REVISED PER DIRT ANALYSIS	
		1/31/06	REVISED PER TAC COMMENTS	

STOEPELWERTH & ASSOCIATES, INC.	
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9940 Allisonville Rd., Fishers, IN 46038-2005	
Phone: (317) 849-5935 Fax: (317) 849-5942	
Toll Free: (800) 728-6917	
CERTIFIED: 1/3/06	
 	
9/27/06	AS BUILTS
4/14/06	REVISED PIER DEVELOPER
5/1/06	REVISED PER DIRT ANALYSIS
1/31/06	REVISED PER TAC COMMENTS

## ▼ PROFILES VE II.

STORM PLAN & F		WINDSOR GRO
DRAWN BY: TWF	CHECKED BY BKR	
SHEET NO. <b>C601</b>		
S & A JOB NO. <b>52645</b>		



# RECORD DRAWING

*Jerry W. Darling*


JERRY W. DARLING  
Registered Land Surveyor  
No. 900017



9/27/06  
DATE

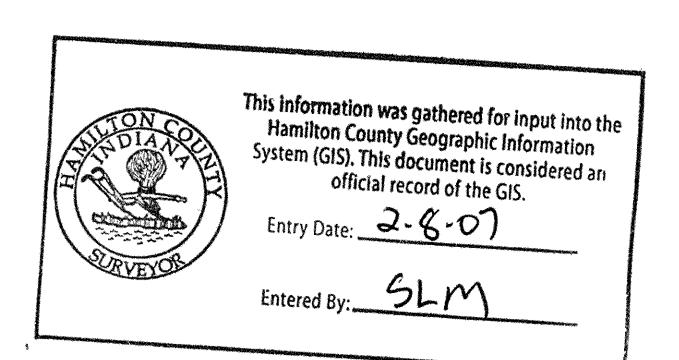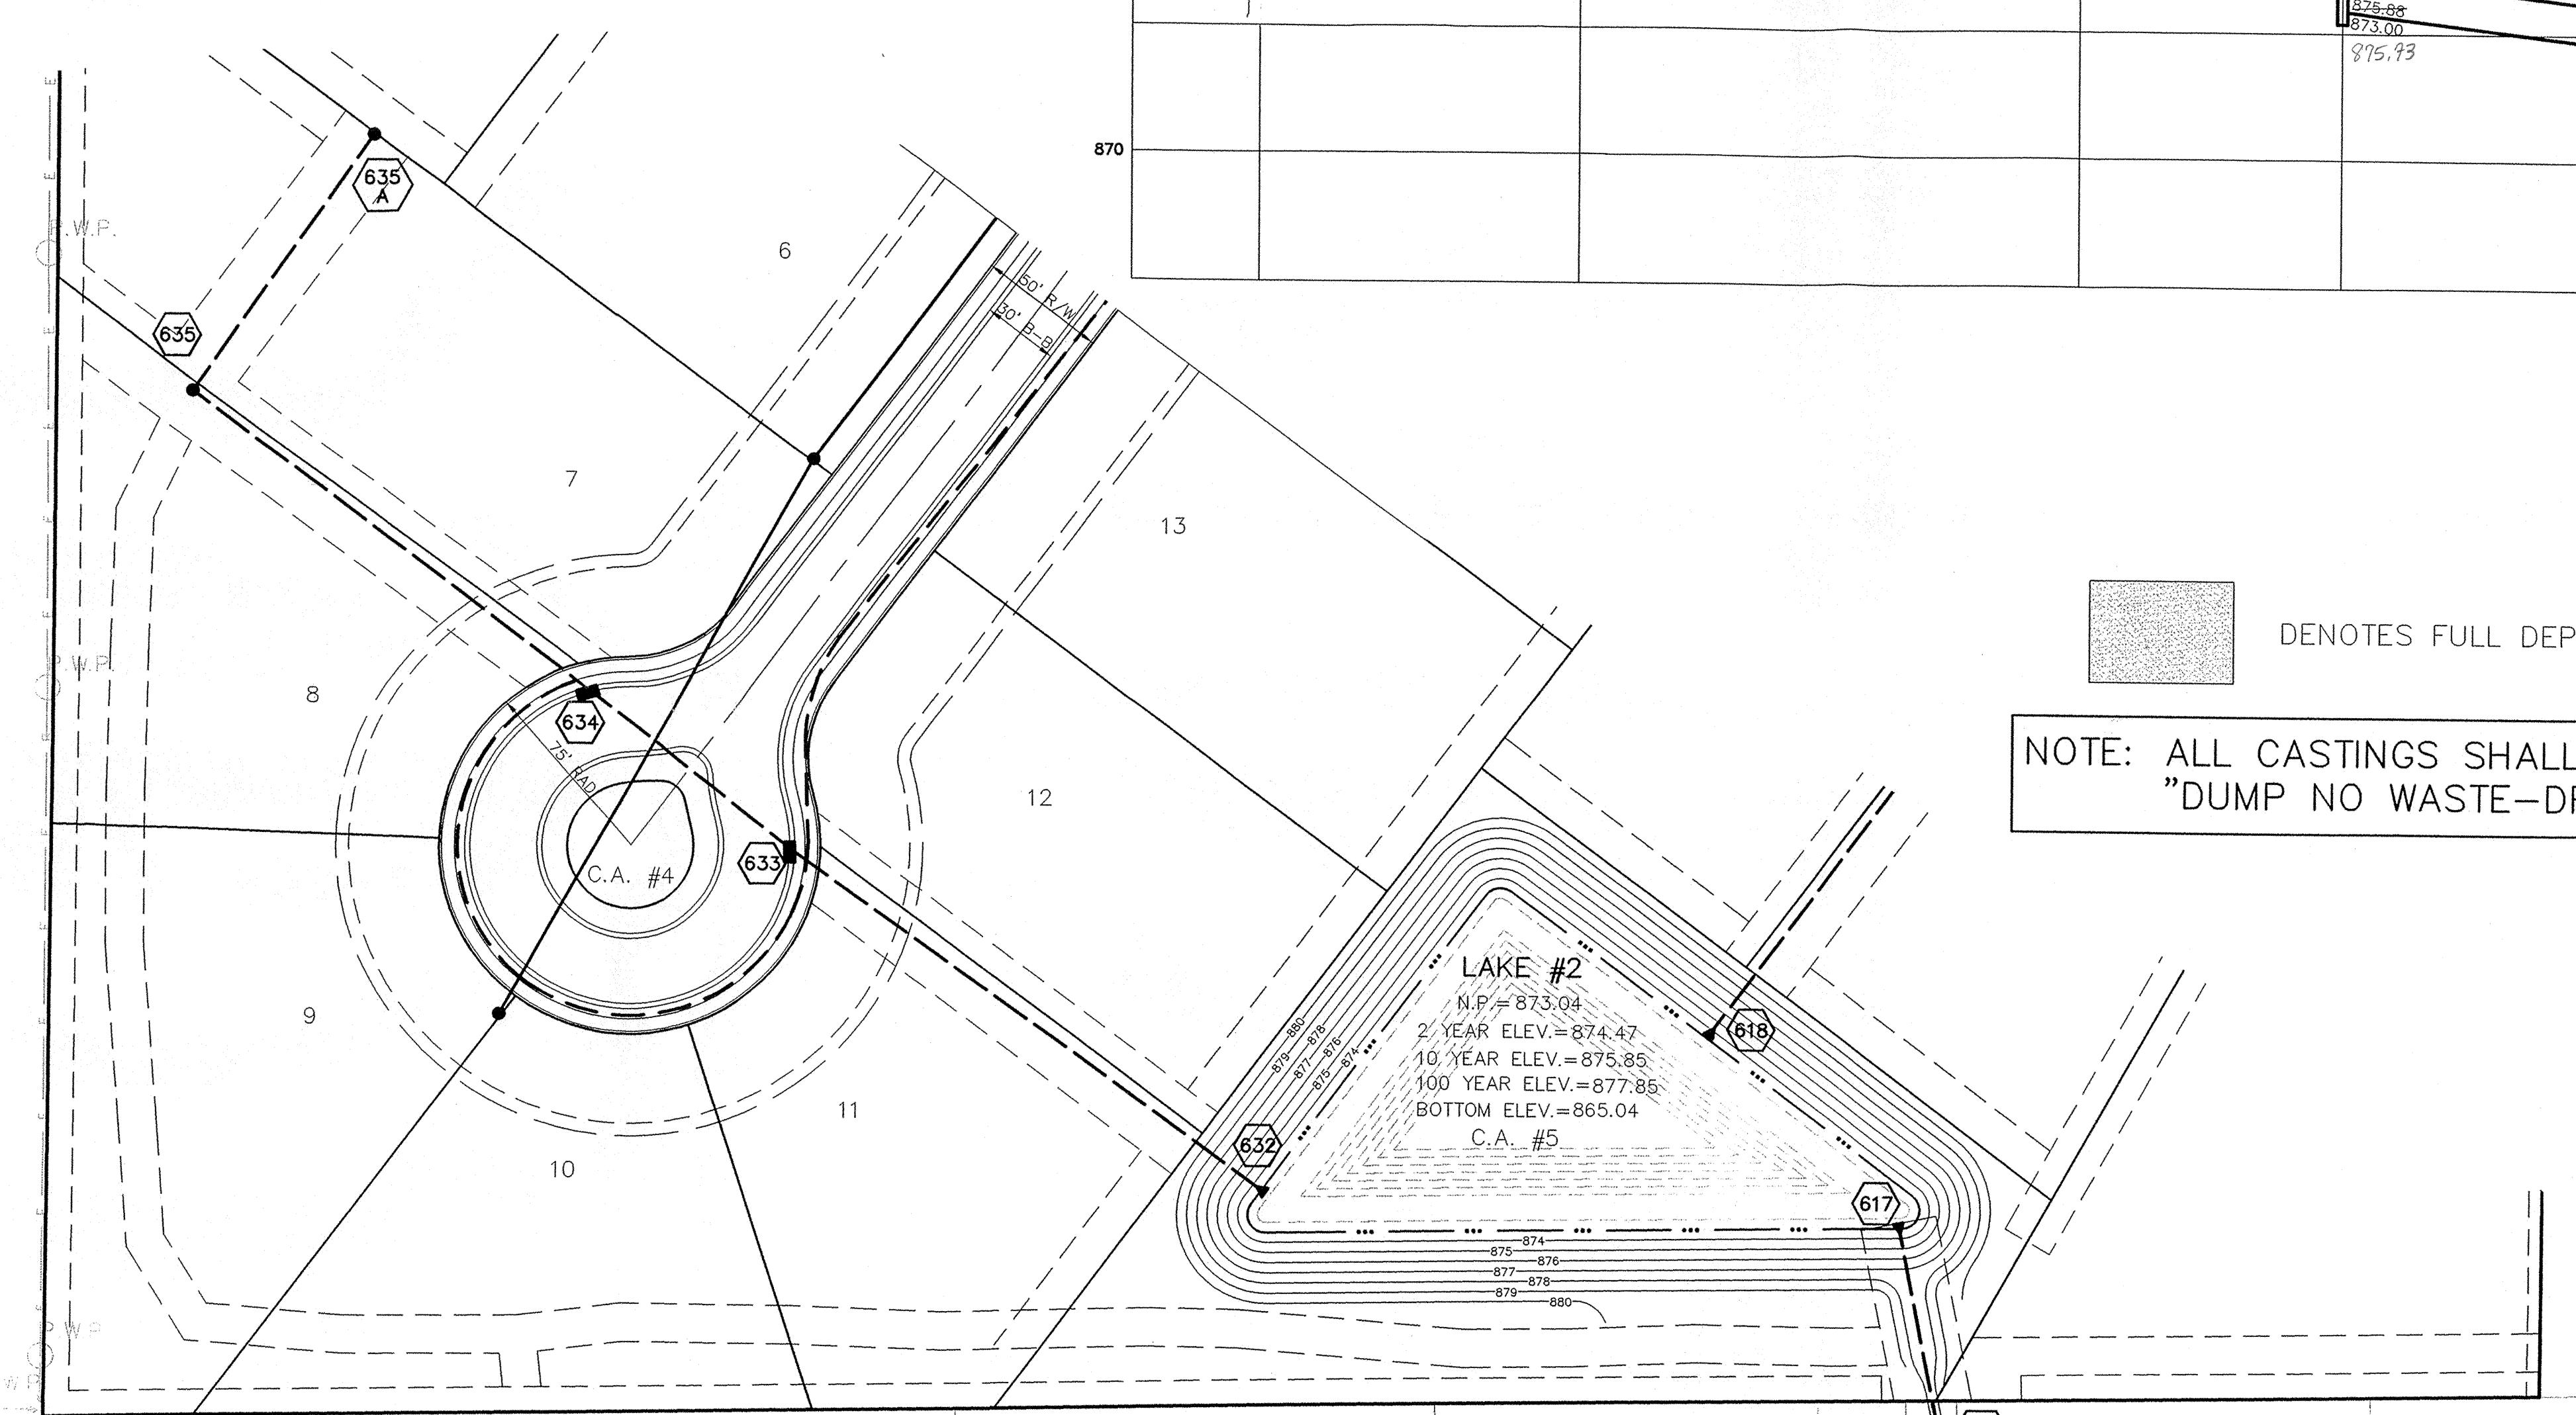

ORIFICE PLATE DETAIL  
STRUCTURE #617  
NOT-TO-SCALE

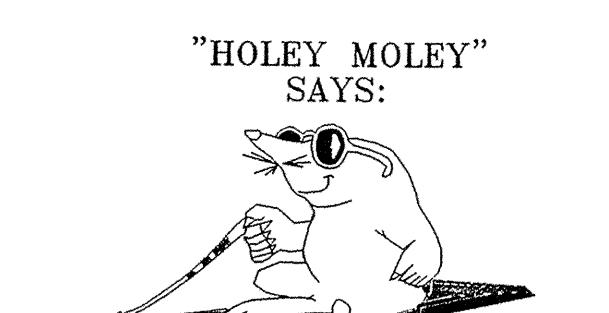

1-800-382-5544  
CALL TOLL FREE

1-800-428-5200  
FOR CALLS OUTSIDE OF INDIANA

1-317-571-2648  
CALL CARMEL UTILITIES  
(FOR WATER MAIN LOCATIONS)

SCALE: 1" = 50'

SCALE: 1"=50' HOR.  
1"=5' VERT.

EXISTING  
YARD INLET 616  
STA. CH 00 T.C. = 877.71

CONCRETE  
END SECTION 617  
STA. CH 00 T.C. (SEE DETAIL)

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EXISTING  
YARD INLET 616  
STA. CH 00 T.C. = 877.71

CONCRETE  
END SECTION 617  
STA. CH 00 T.C. (SEE DETAIL)

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YARD INLET 616  
STA. CH 00 T.C. = 877.71

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EXISTING  
YARD INLET 616  
STA. CH 00 T.C. = 877.71

CONCRETE  
END SECTION 617  
STA. CH 00 T.C. (SEE DETAIL)


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STA. CH 00 T.C. = 877.71

CONCRETE  
END SECTION 617  
STA. CH 00 T.C. (SEE DETAIL)


EXISTING  
YARD INLET 616  
STA. CH 00 T.C. = 877.71

CONCRETE  
END SECTION 617  
STA. CH 00 T.C. (SEE DETAIL)

EXISTING  
YARD INLET

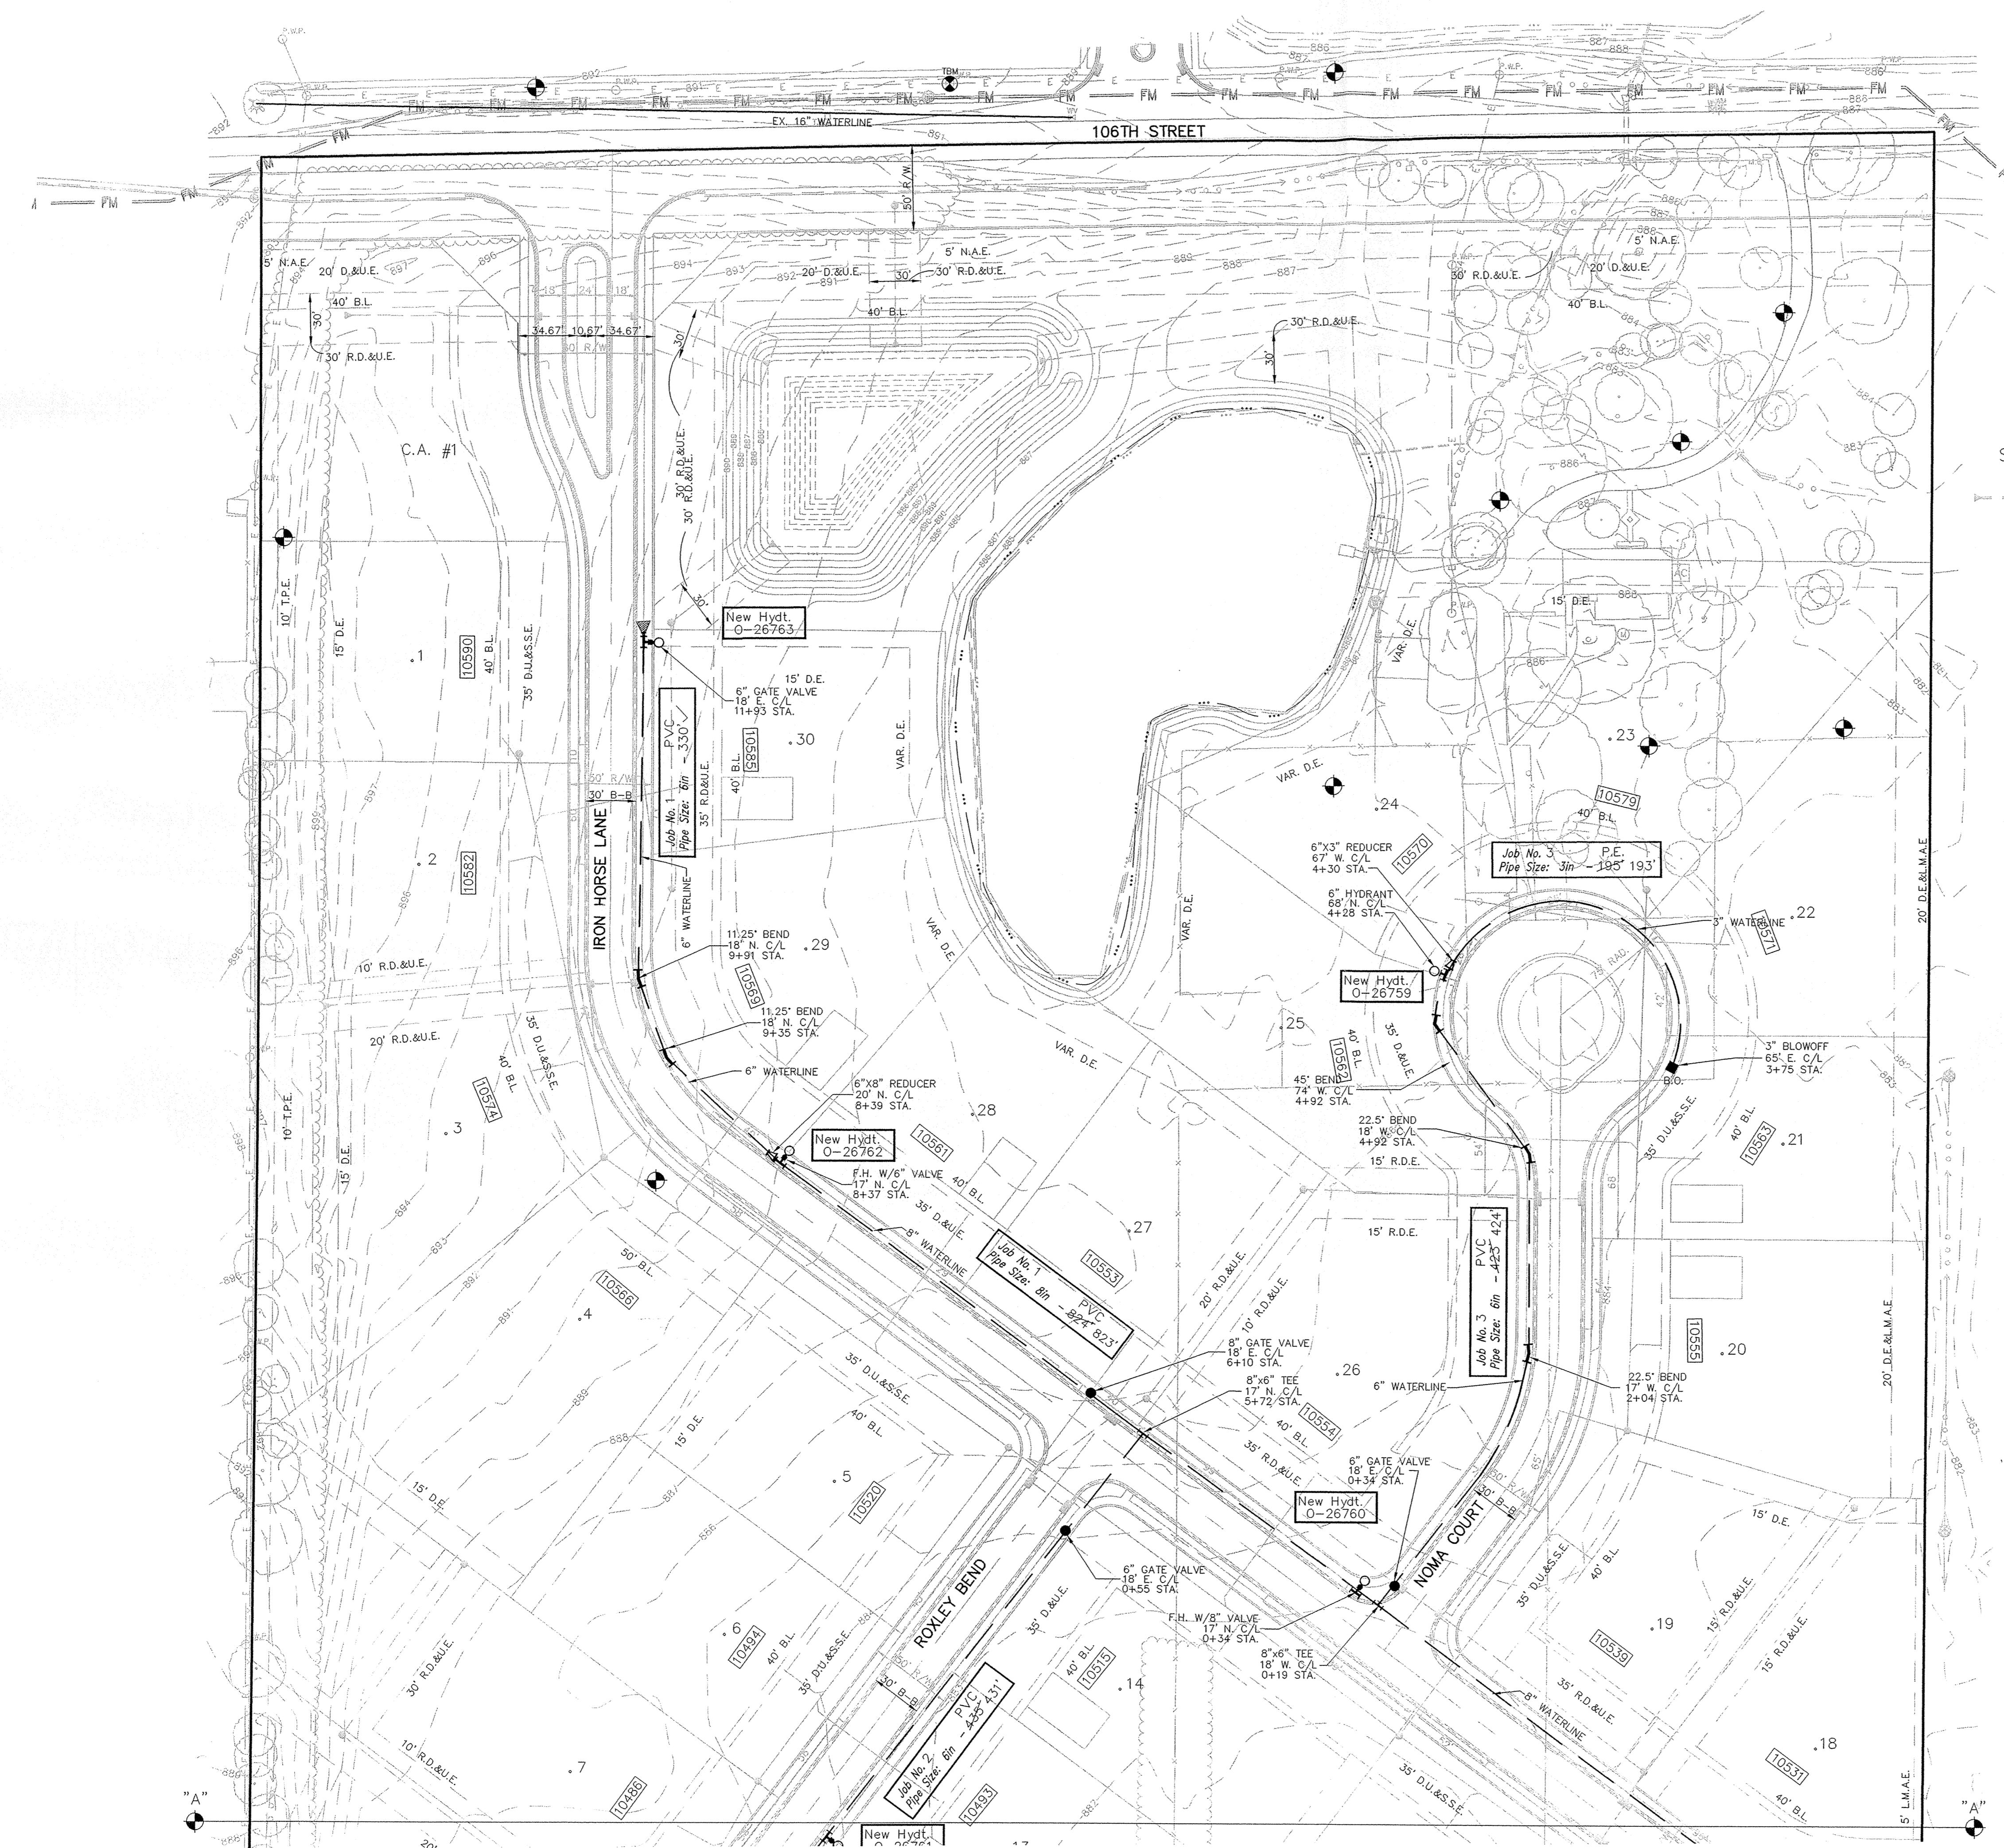


Project Location  
Scale: 1"=2000'

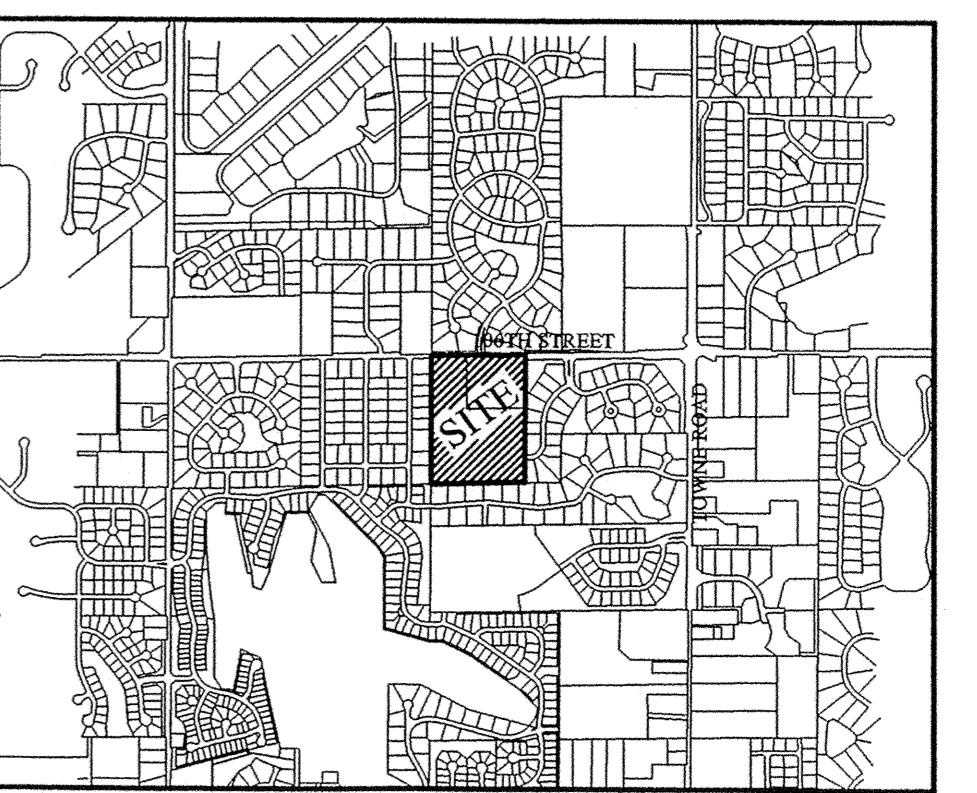

SCALE: 1" = 50'


INDIANAPOLIS WATER PROJECT LEGEND			
Project Name: WINDSOR GROVE, SECTION 2			
Project Number: J-06-103			
Job #	Street Name	Pipe Size	Pipe Type
1	IRON HORSE LANE	8"	PVC
1	IRON HORSE LANE	6"	PVC
2	ROXLEY BEND	6"	PVC
2	ROXLEY BEND	3"	PE
3	NOMA COURT	6"	PVC
3	NOMA COURT	3"	PE
		TOTAL	2515' 2500'

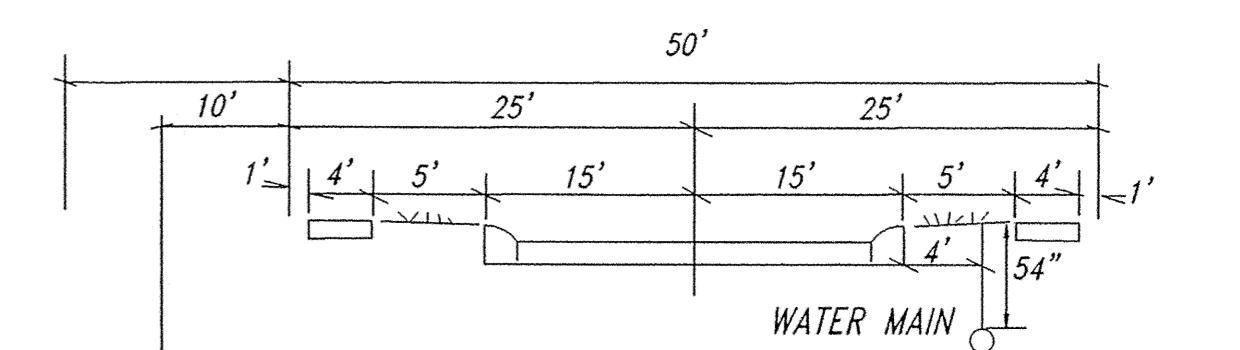

TYPICAL STREET  
No Scale

## RECORD DRAWING

Jeff W Darling  
8/30/06  
JEFFORY W. DARLING  
Registered Land Surveyor  
No. 900017

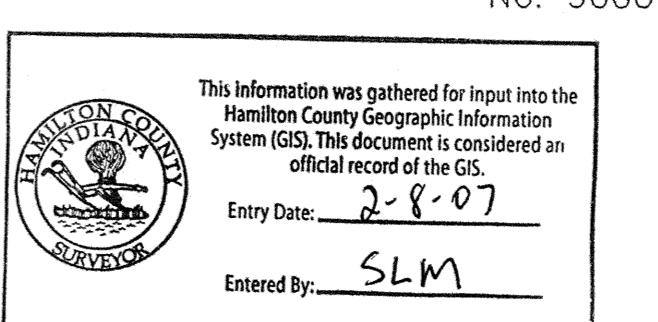

This information was gathered for input into the Hamilton County Geographic Information System (GIS). This document is considered an official record of the GIS.  
Entry Date: 2-8-07  
Entered By: SLM

### LEGEND

- Existing Water Main
- Proposed Water Main
- Inlet
- Tree
- Parcel Id
- Hydrant
- Hydrant with Hydrant Valve
- Butterfly Valve
- Valve
- Blowoff Assembly
- △ Air Relief Valve
- Plug
- Reducer
- T.J. Tee
- M.J. Sleeve
- Bend
- Kicker Block
- Cross
- Casing Pipe
- Gas Lines
- Telephone Lines
- Electric Lines

"HOLEY MOLEY"  
SAYS:




1-800-382-5544  
CALL TOLL FREE  
1-800-428-5200  
FOR CALLS OUTSIDE OF INDIANA

CAUTION  
LOCATION OF ALL EXISTING UNDERGROUND UTILITIES SHOWN ON THIS PLAN ARE BASED UPON THE BEST GROUND EVIDENCE, (INCLUDING, BUT NOT LIMITED TO, SURFACE MARKINGS & MARKS MADE UPON THE GROUND BY OTHERS) AND ARE NOT A PREDICTIVE DRAWING. THERE ALSO MAY BE OTHER EXISTING UNDERGROUND UTILITIES FOR WHICH THERE IS NO ABOVE GROUND EVIDENCE. IT IS THE DRAFTER'S RESPONSIBILITY TO ENSURE THAT NO EXISTING UTILITIES ARE DISTURBED OR DAMAGED DURING CONSTRUCTION. FOR THIS REASON, THE EXACT LOCATIONS OF SAD EXISTING UNDERGROUND UTILITIES SHOULD BE VERIFIED BY THE CONTRACTOR PRIOR TO ANY AND ALL CONSTRUCTIONS.


## WATER PLAN

## WINDSOR GROVE II

DRAWN BY: TWF  
CHECKED BY: BKR  
SHEET NO. C700  
S & A JOB NO. 52645

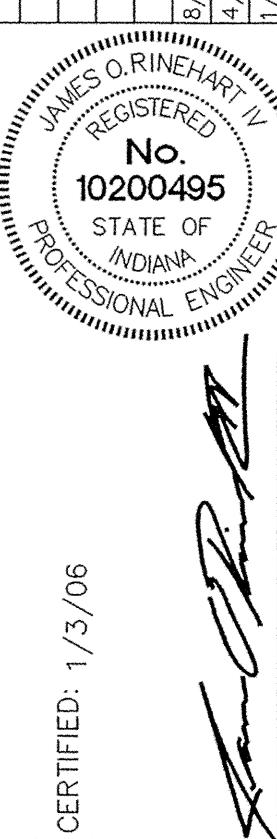


STOEPPELWERTH & ASSOCIATES, INC.  
CONSULTING ENGINEERS & LAND SURVEYORS  
CERTIFIED: 1/3/06  
9940 Allisonville Rd., Fishers, IN 46038-2005  
Phone: (317) 849-5935 Fax: (317) 849-5942  
Toll Free: (800) 728-6917

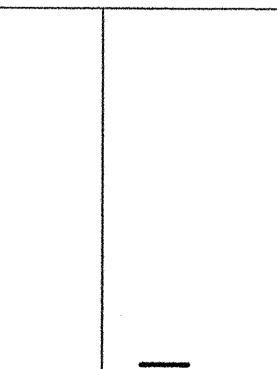


JEFFORY W. DARLING  
REGISTERED LAND SURVEYOR  
No. 900017  
STATE OF INDIANA


HAMILTON COUNTY, INDIANA

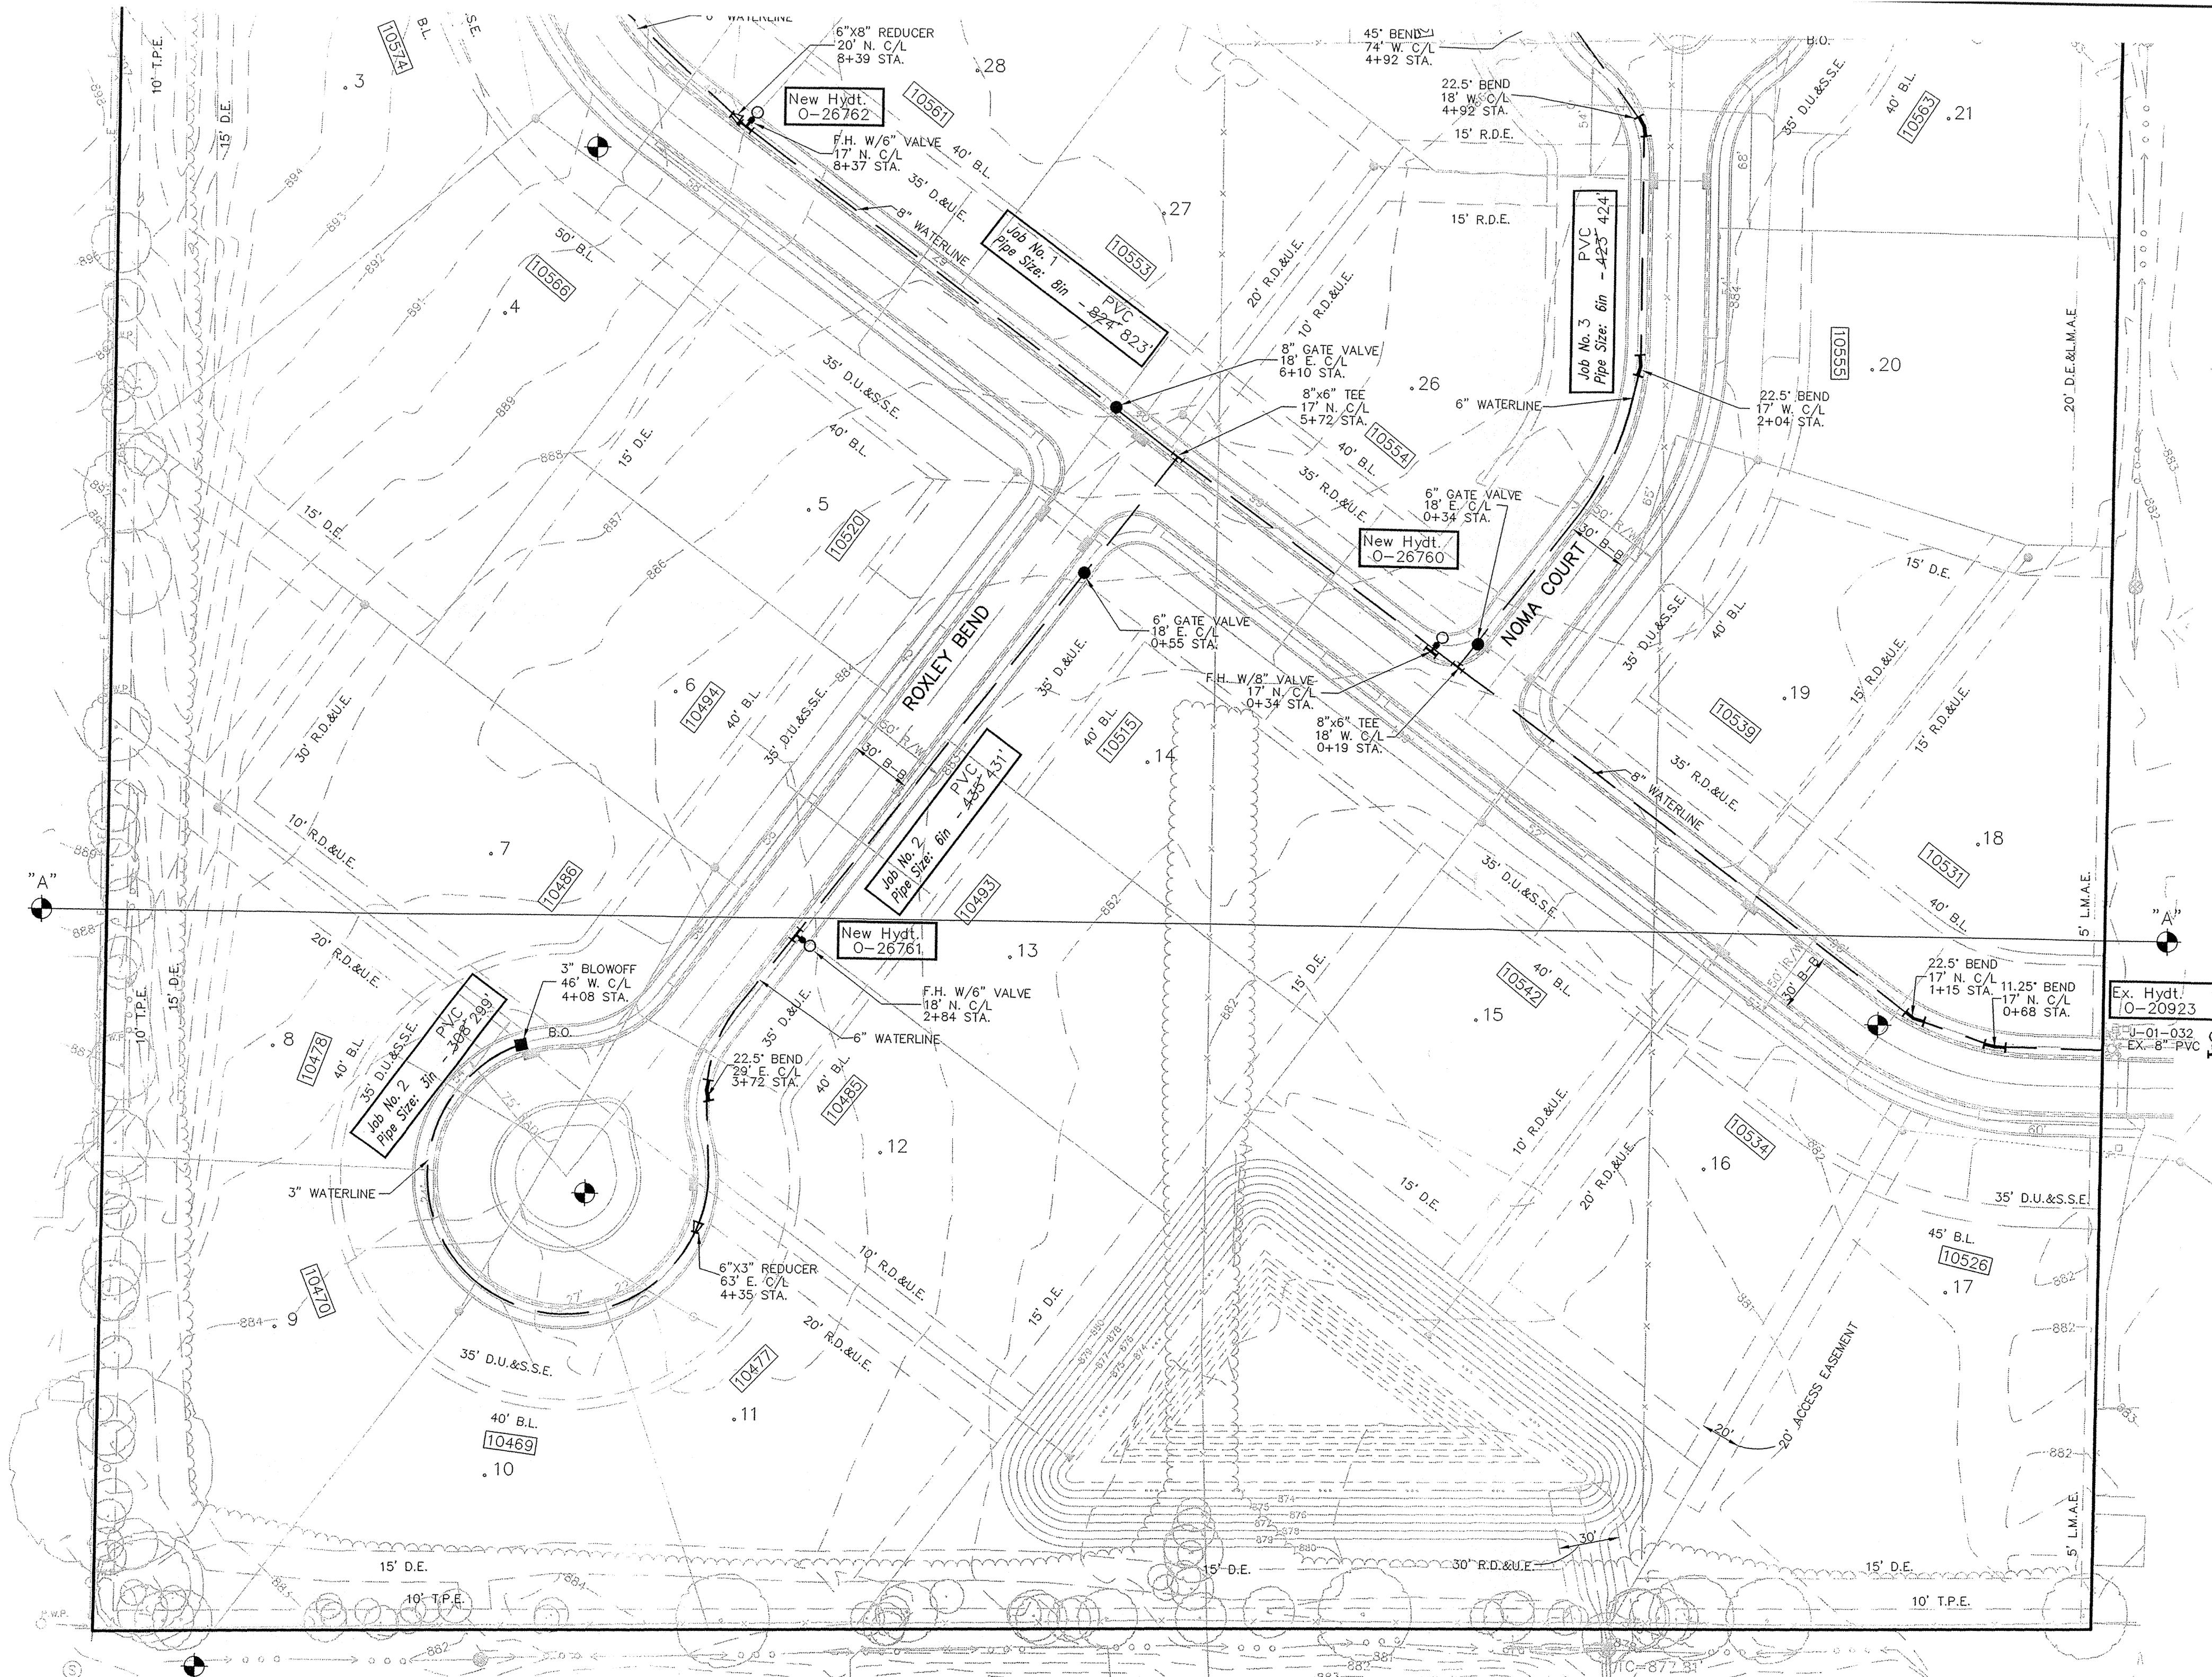

Project Location  
Scale: 1"=2000'

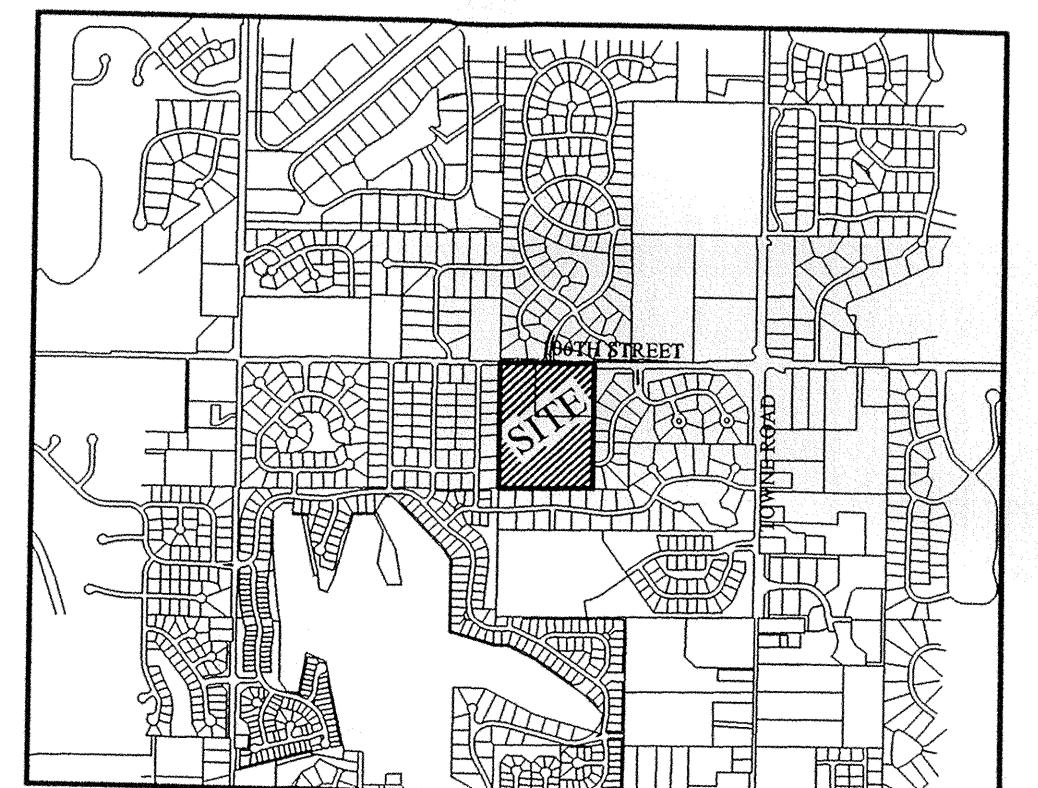


SCALE: 1" = 50'

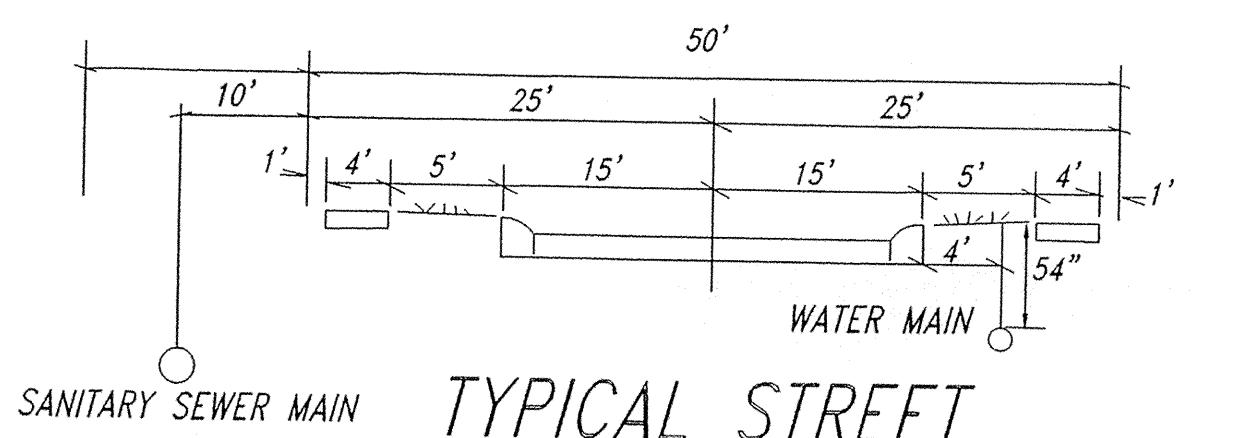

## RECORD DRAWING

*Jeff W Darling*  
JEFFORY W. DARLING  
Registered Land Surveyor  
No. 900017  
8/30/06  
DATE

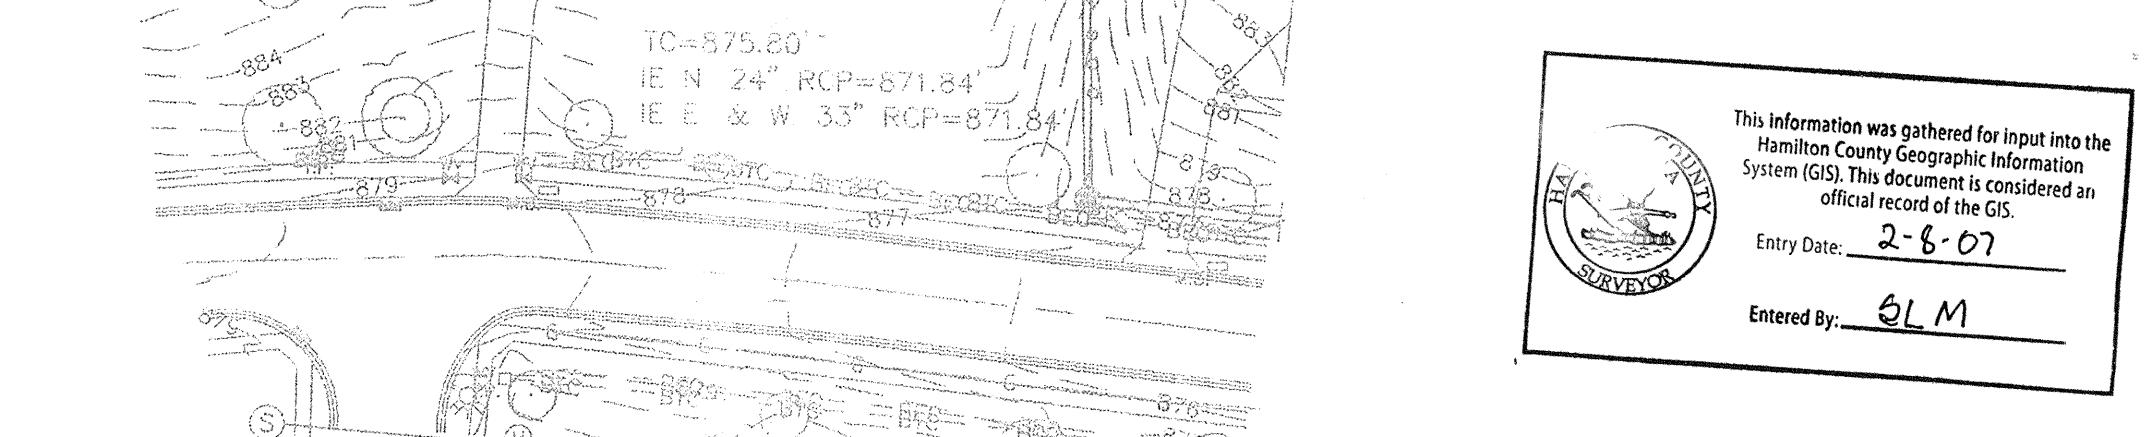


TC=877.01  
IE E. 24" RCP=871.84'  
IE E. & W. 33" RCP=871.84'  
TC=875.80  
IE N. 24" RCP=872.85'  
IE S. 24" RCP=872.85'

Project Name WINDSOR GROVE, SECTION 2  
Project Number J-06-103  
Dist. Map No. 704  
Meter Map No. 7044  
Lots 30  
Tax Code 29003  
Pressure Dist LAFAYETTE  
Drafter STOEPPELWERTH/KMC/BKR  
Date 3/06

### LEGEND

- - -	Existing Water Main
- - - -	Proposed Water Main
□	Inlet
○	Tree
•	Parcel Id
△	Adapter
■	Bend
□	Kicker Block
Hydrant	Hydrant
Hydrant with Hydrant Valve	Hydrant Valve
Butterfly Valve	Butterfly Valve
Valve	Valve
Blowoff Assembly	Blowoff Assembly
Air Relief Valve	Air Relief Valve
Plug	Plug
Reducer	Reducer
T.J. Tee	T.J. Tee
M.J. Sleeve	M.J. Sleeve
Cross	Cross
G	Casing Pipe
T	Gas Lines
E	Telephone Lines
	Electric Lines

"HOLEY MOLEY"  
SAYS:

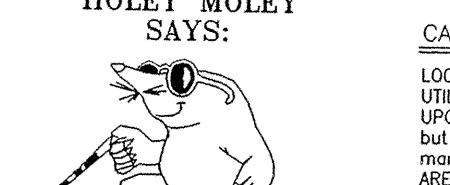

LOCATION OF ALL EXISTING UNDERGROUND UTILITIES SHOWN ON THIS PLAN ARE BASED UPON ABOVE GROUND EVIDENCE. (including, but not limited to, measurements, survey marks made upon the ground by others,) & ARE SPECULATIVE IN NATURE. THERE MAY ALSO BE OTHER UNSHOWN UTILITIES IN THE GROUND FOR WHICH THERE IS NO ABOVE GROUND EVIDENCE OR FOR WHICH NO ABOVE GROUND DIVISIONS EXIST. CONTRACTORS ARE RESPONSIBLE FOR SIGHTING EXISTING UTILITIES SHOWN ON THIS PLAN PRIOR TO ANY AND ALL CONSTRUCTION.

1-800-382-5544  
CALL TOLL FREE  
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FOR CALLS OUTSIDE OF INDIANA

## WATER PLAN

## WINDSOR GROVE II

STOEPPELWERTH & ASSOCIATES, INC.

CERTIFIED: 1/3/06  
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9940 Allisonville Rd., Fishers, IN 46038-2005  
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Toll Free: (800) 728-6917

James O'Rinechart  
No. 10200495  
STATE OF  
INDIANA  
PROFESSIONAL ENGINEER  
KMC  
AAA  
BY

*Jeff W Darling*  
JEFFORY W. DARLING  
REGISTERED LAND SURVEYOR  
No. 900017  
STATE OF  
INDIANA  
LAND SURVEYOR  
INDIANA  
HAMILTON COUNTY, INDIANA

DRAWN BY: .TWF  
CHECKED BY: BKR  
SHEET NO. C701  
CARMEL  
S & A JOB NO. 52645

STRUCTURE DATA																					
STRUCTURE NUMBER	LOCATION	LEFT	RIGHT	CROSS	SIZE INCHES	DESCRIPTION SEE ST'D. SHEET "MP" FOR ACCEPTABLE TYPE OF PIPE WITH- IN EACH GROUP.	LENGTH	SKW	FLOW LINE		CONCRETE CLASS "A"	BORROW FOR STR. BACKFILL	BACKFILL METHOD	GAGES OR THICKNESS STEEL	ALUM.	REINF. STEEL	VELOCITY	RIPRAP	PIPE END SECTION	REMARKS	
									COVER	UP STREAM	DOWN STREAM					SYS	EA.	LBS.			
CONNALIGHT DRIVE		"PR-1"		CMP		47		887.25 885.25								CONNECT TO STR. NO. 21					
1	1+40 PR-4 <sup>1</sup>	✓	12"	CMP		28		890.25 889.98													
2	3+15	✓	12"	CMP		26		890.90 890.72													
3	6+10	✓	12"	CMP		28		891.76 891.57													
4	7+34	✓	12"	CMP		20		892.00 891.86													
5	7+71	✓	12"	CMP		26		893.96 893.71													
6	9+68	✓	12"	CMP		25		894.50 894.26													
FERGUS AVENUE		"PR-2"		CMP		28		886.75 886.47													
8	1+80	✓	12"	CMP		30		887.33 887.11													
9	2+58	✓	12"	CMP		23		888.00 887.83													
10	3+51	✓	12"	CMP		27		888.88 888.67													
11	4+63	✓	12"	CMP		27		890.00 889.79													
12	6+10	✓	12"	CMP		25		891.24 891.06													
13	7+85	✓	12"	CMP		28		892.00 891.80													
GREENTREE DRIVE		"PR-3"		PRECAST INLET		24		881.26 881.26						T.C. = 883.00							
15	1+72	✓	12"	CMP		24		883.54 883.19													
16	1+97	✓	12"	CMP		18		884.62 884.36													
17	2+75	✓	12"	CMP		25		886.96 886.58													
18	4+32	✓	12"	CMP		27		890.00 889.61													
19	6+42	✓	12"	CMP		21		892.35 891.69													
20	7+20	✓	12"	CMP		31		880.31 880.31						T.C.=883.00 (SEE SHT. #6 FOR LOC.)							
ANNALLY DRIVE		"PR-4"		PRECAST INLET		24		885.24						T.C.=888.00 (CONN. TO BUTT PIPE)							
21	0+40	✓	10"	PIPE INLET		28		883.00 883.00						T.C.=887.50 (CONN. TO BUTT PIPE)							
22	1+53	✓	10"	PIPE INLET		18		884.62 884.43						T.C.=887.00 (CONN. TO BUTT PIPE)							
23	2+65	✓	10"	PIPE INLET		22		883.96 883.81						T.C.=886.00 (CONN. TO BUTT PIPE)							
24	3+74	✓	10"	PIPE INLET		24		883.00 883.00						T.C.=886.00 (CONN. TO BUTT PIPE)							
25	4+73	✓	12"	PRECAST INLET		38		885.00 884.75						CONNECT TO STR. NO. 23							
26	4+80	✓	12"	CMP		28		884.62 884.43						T.C. 885.00 (CONN. TO BUTT PIPE)							
27	5+67	✓	10"	PIPE INLET		18		884.41 884.29						T.C. 885.50 (CONN. TO BUTT PIPE)							
28	6+79	✓	10"	PIPE INLET		22		883.96 883.81						T.C. 883.25 (CONN. TO BUTT PIPE)							